
Sheet Number	Sheet Name	Sheet Issue Date
0-COVER		
A-000	COVER SHEET	01/29/21
1-CIVIL		
C-0	EXISTING SITE PLAN	01/14/2021
C-1	PROPOSED CIVIL SITE PLAN	01/14/2021
C-2	CIVIL DETAILS	01/14/2021
C-3	CIVIL DETAILS	01/14/2021
C-4	DEMOLITION AND EROSION CONTROL PLAN	01/14/2021
2-LANDSC		01 /20 /21
L-1	LANDSCAPE PLAN	01/29/21
L-2	PLANTING & MATERIALS	01/29/21
L-3	GREEN SCORE CALCULATIONS	01/29/21
L-4	SITE DETAILS	01/29/21
L-5	SITE DETAILS	01/29/21
3-EXISTING	CONDITIONS	
A-019	DEMO Plans & Elevations	02/19/2020
4-ARCHTIT	FCTURAL	
A-020	ARCHITECTURAL SITE PLAN	01/29/21
A-101	FLOOR PLANS	01/29/21
A-102	FLOOR PLANS	01/29/21
A-103	FLOOR PLANS	01/29/21
A-104	ROOF PLAN	01/29/21
A-300	EXTERIOR ELEVATIONS	01/29/21
A-302	FASCADE CALC. & SIGN PLANS	01/29/21
AV-1	PERSPECTIVES	01/29/21
AV-2	RENDERING	01/29/21

DRAWING LIST

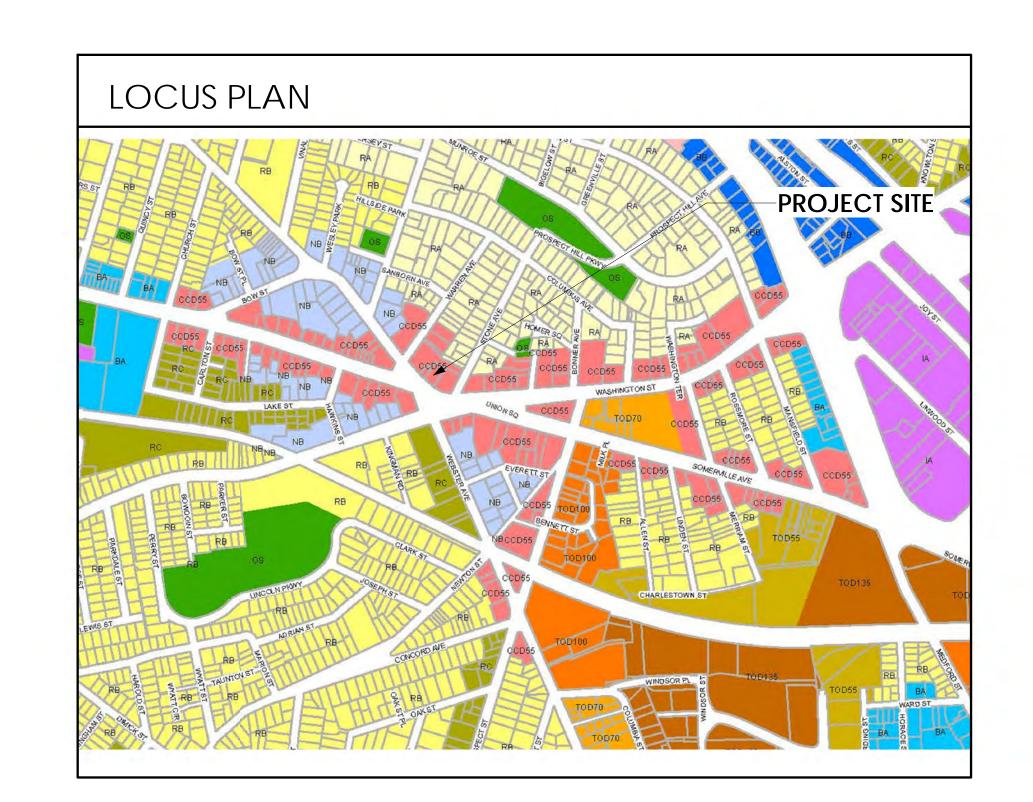



379 SOMERVILLE AVE MIXED-USE BUILDING 6/02/21 PLANNING BOARD RE-SUBMISSION

PROJECT ADDRESS: 379 SOMERVILLE AVE SOMERVILLE, MASSACHUSETTS

<u>CLIENT</u> 379 SOMERVILLE AVE,LLC PO BOX 610312

NEWTON, MA 02461

CIVIL/SURVEY PETER NOLAN & ASSOCIATES LLC. 697 CAMBRIDGE ST., SUITE 103 BRIGHTON, MA 02135 T: 857-891-7478

<u>ARCHITECT</u>

KHALSA DESIGN INC.

17 IVALOO STREET, SUITE 400 SOMERVILLE, MA 02143 T:(617)-591-8682

<u>LANDSCAPE</u>

VERDANT LANDSCAPE ARCHITECTS

318 HARVARD AVE, SUITE 25 BROOKLINE, MA 02446 T:(617)-735-1180

PROJECT NAME THUNDER ROAD **PROJECT ADDRESS**

379 Somerville Ave Somerville, MA CLIENT **379 SOMERVILLE AVE, LLC**

ARCHITECT



17 IVALOO STREET SUITE 400 SOMERVILLE, MA 02143 TELEPHONE: 617-591-8682 FAX: 617-591-2086

CONSULTANTS:


COPYRIGHT KDI © 2019 THESE DRAWINGS ARE NOW AND DO REMAIN THE SOLE PROPERTY OF KHALSA


REGISTRATION

19041 5/18/2021 ASB JSK REVISIONS

COVER SHEET

A-000 THUNDER ROAD

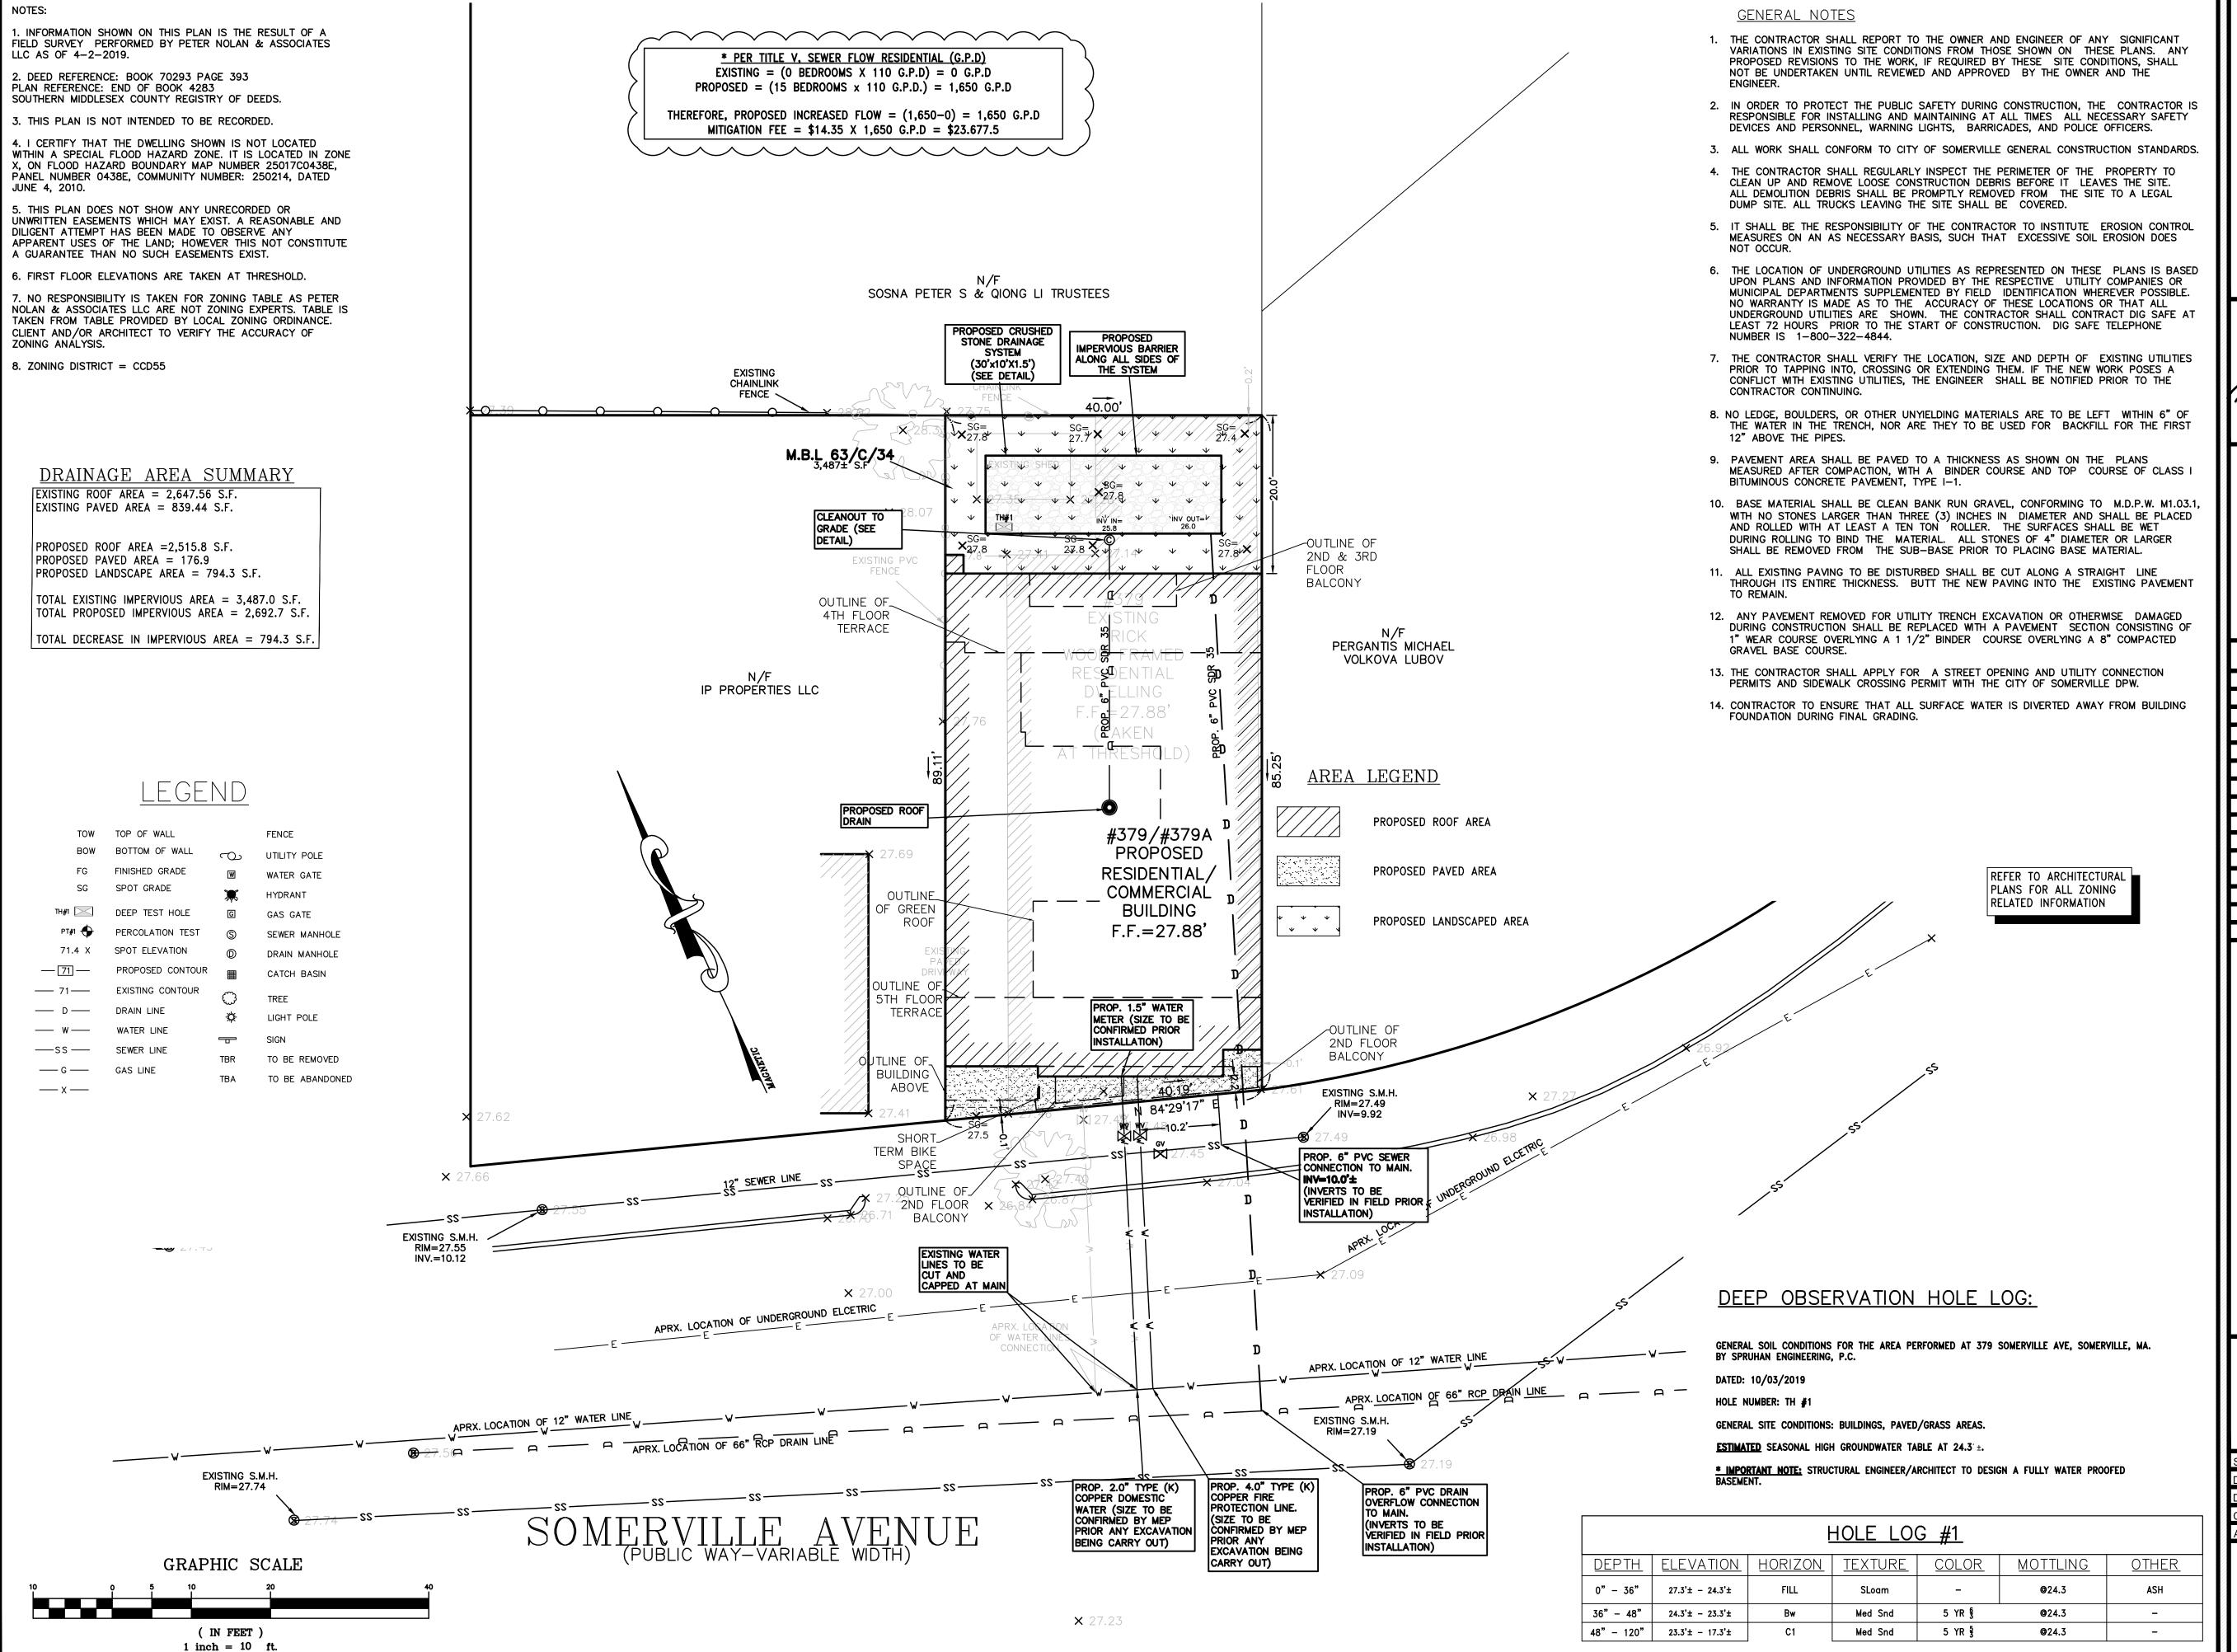

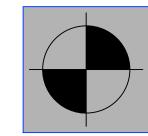






OLAN & SPRUHAN 'ES, LLC ENGINEERING, P.C.

LAND SURVEYORS/CIVIL
ENGINEERING CONSULTANTS
697 CAMBRIDGE STREET,
(SUIT103),
BRIGHTON, MA 02135

Tel:857-891-7478
617-782-1533

80 JEWETT ST, (SUITE 1) NEWTON, MA 02458 Tel: 617-816-0722 Email:edmond@spruhaneng.com

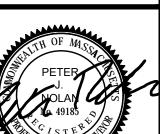

Fax:617-2025691



379 SOMERVILLE AVE SOMERVILLE, MASSACHUSETTS

CK
DATE


All legal rights including, but not limited to, copyright and design patent rights, in the designs, arrangements and plans shown on this document are the property of Peter Nolan & Associates, LLC, or Spruhan Engineering, P.C. They may not be used or reused in whole or in part, except in connection with this project, without the prior written consent of Spruhan Engineering, dimensions on these drawings shall have precedence over dimensions. Contractors shall verify and be responsible for dimensions and conditions on this project, and Spruhan Engineering, P.C., must be notified of any variation from the dimensions and conditions shown by these drawings.


CIVIL PLAN (FOR PLANING PURPOSES ONLY)

//	
SCALE:	1" = 10'
DATE:	1/14/2020
DRAWN BY:	GP
CHECKED BY:	ES
APPROVED BY:	ES

SHEET:

1 OF 4

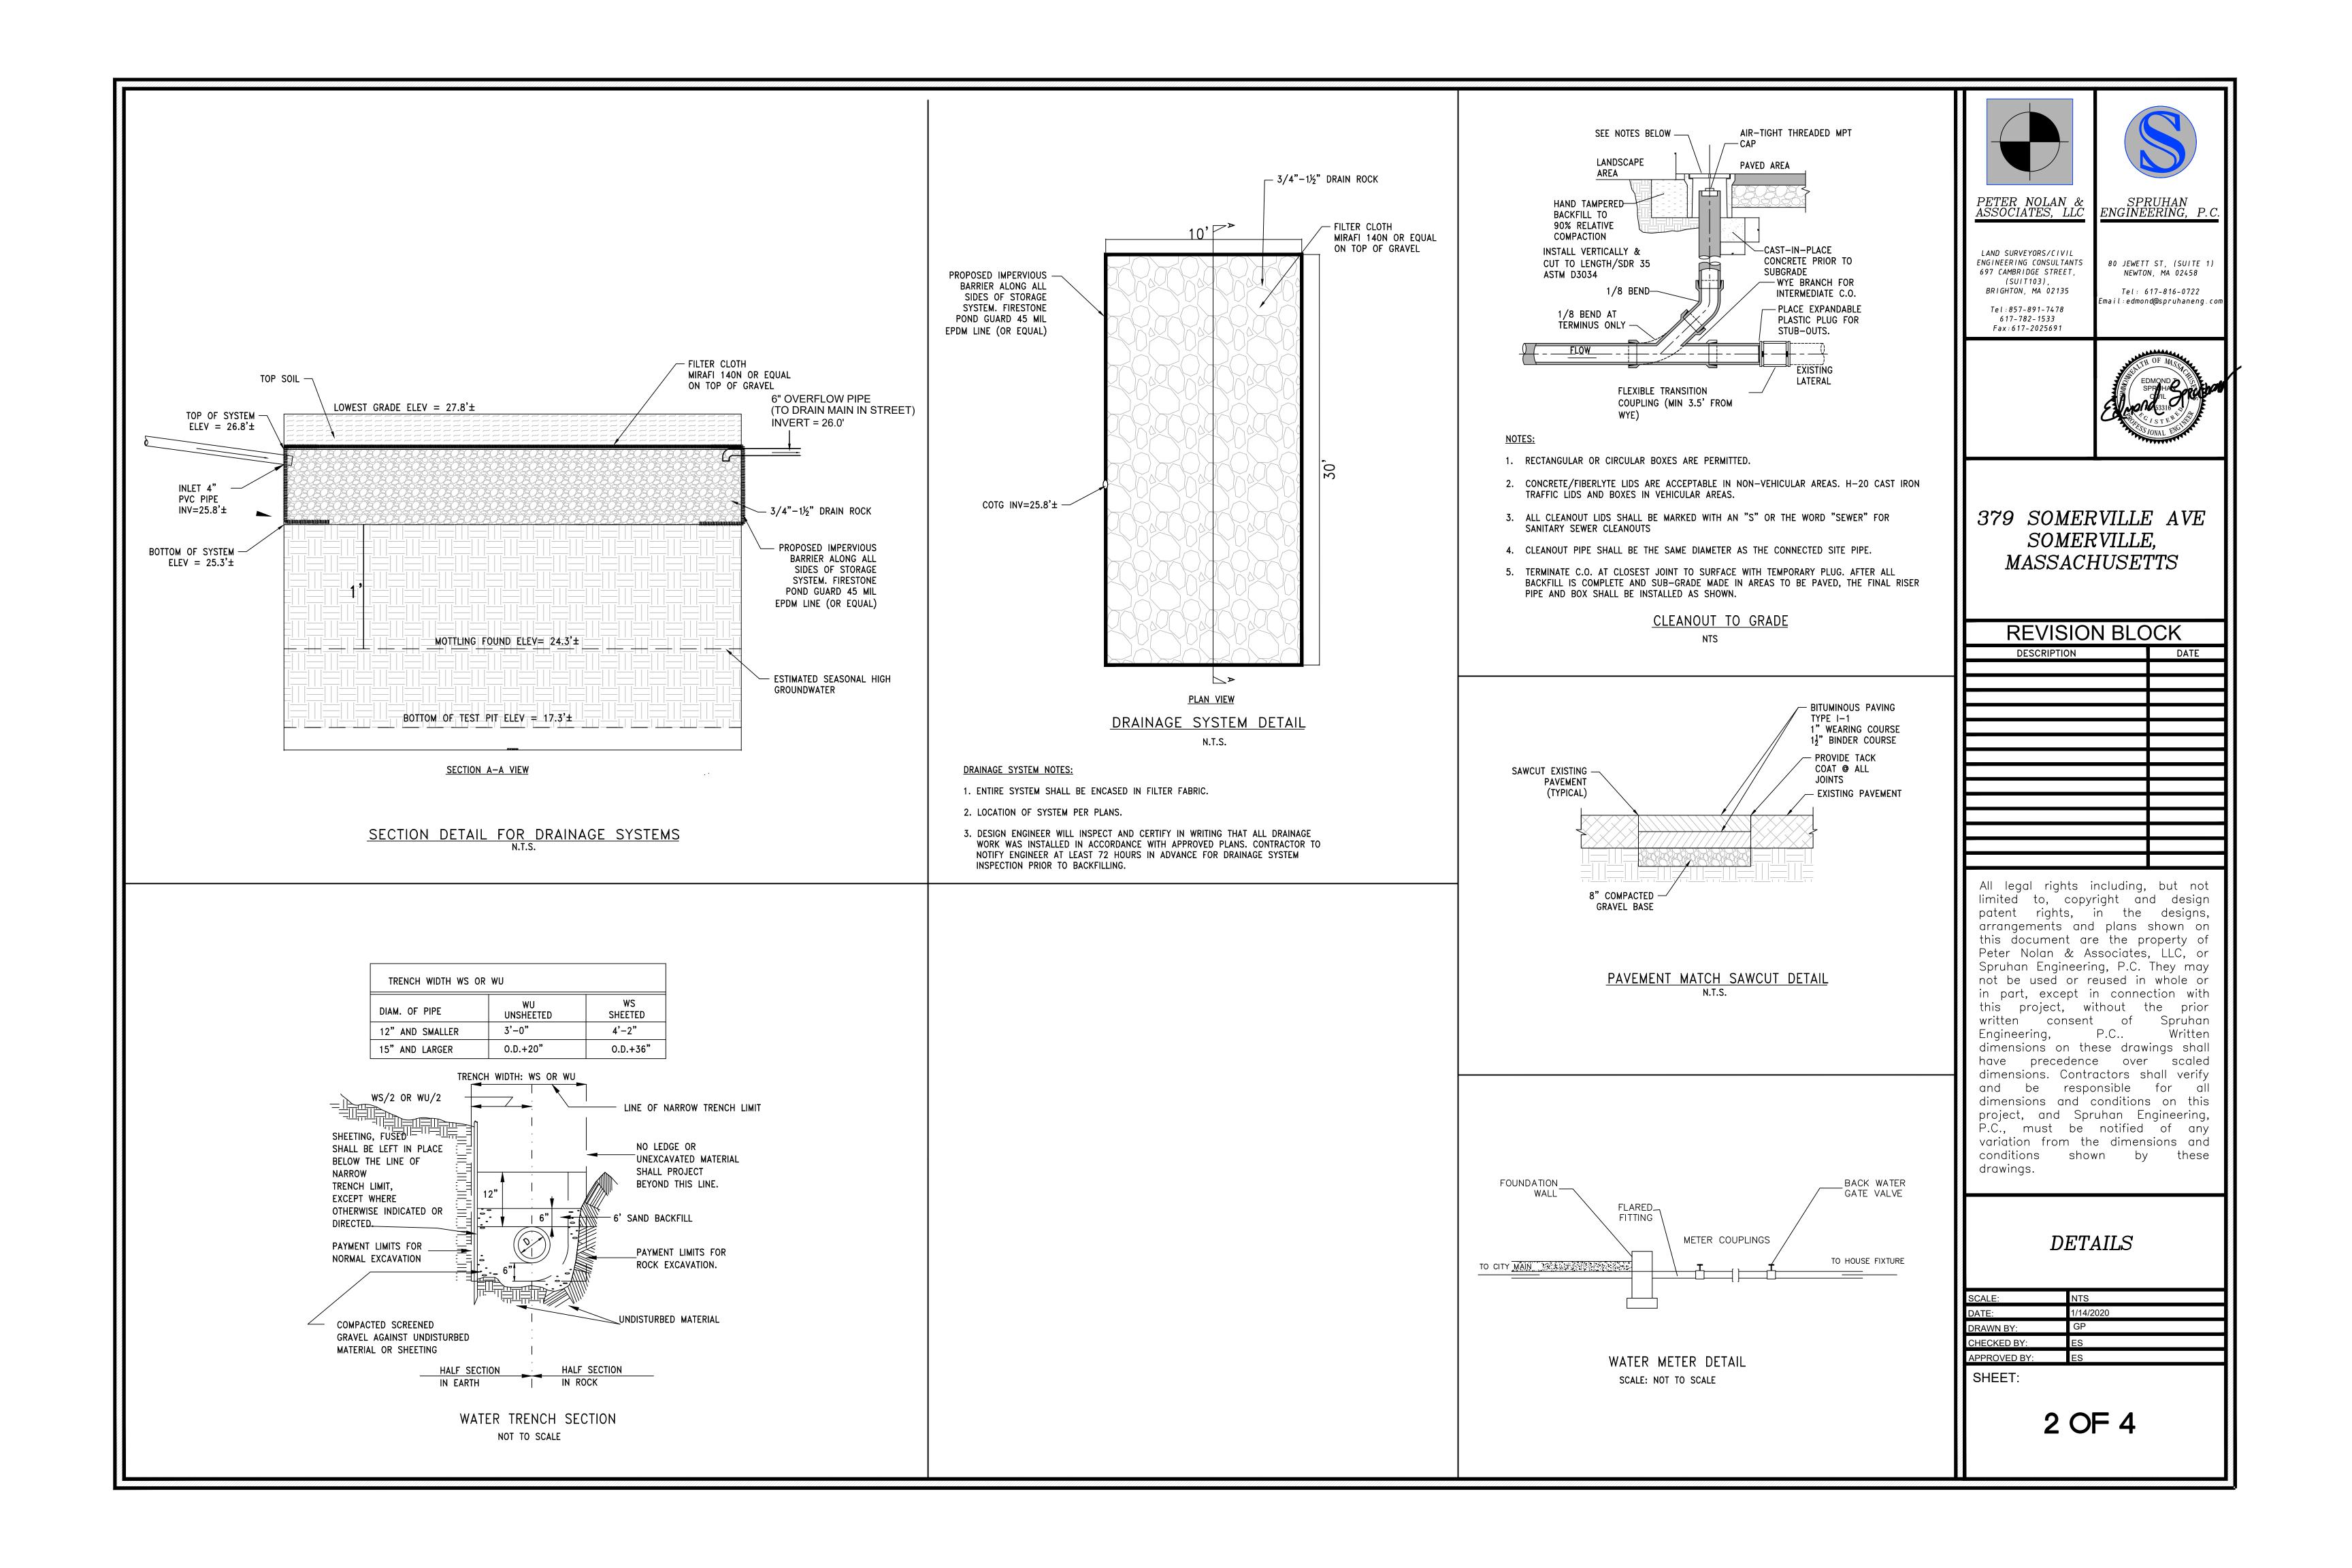

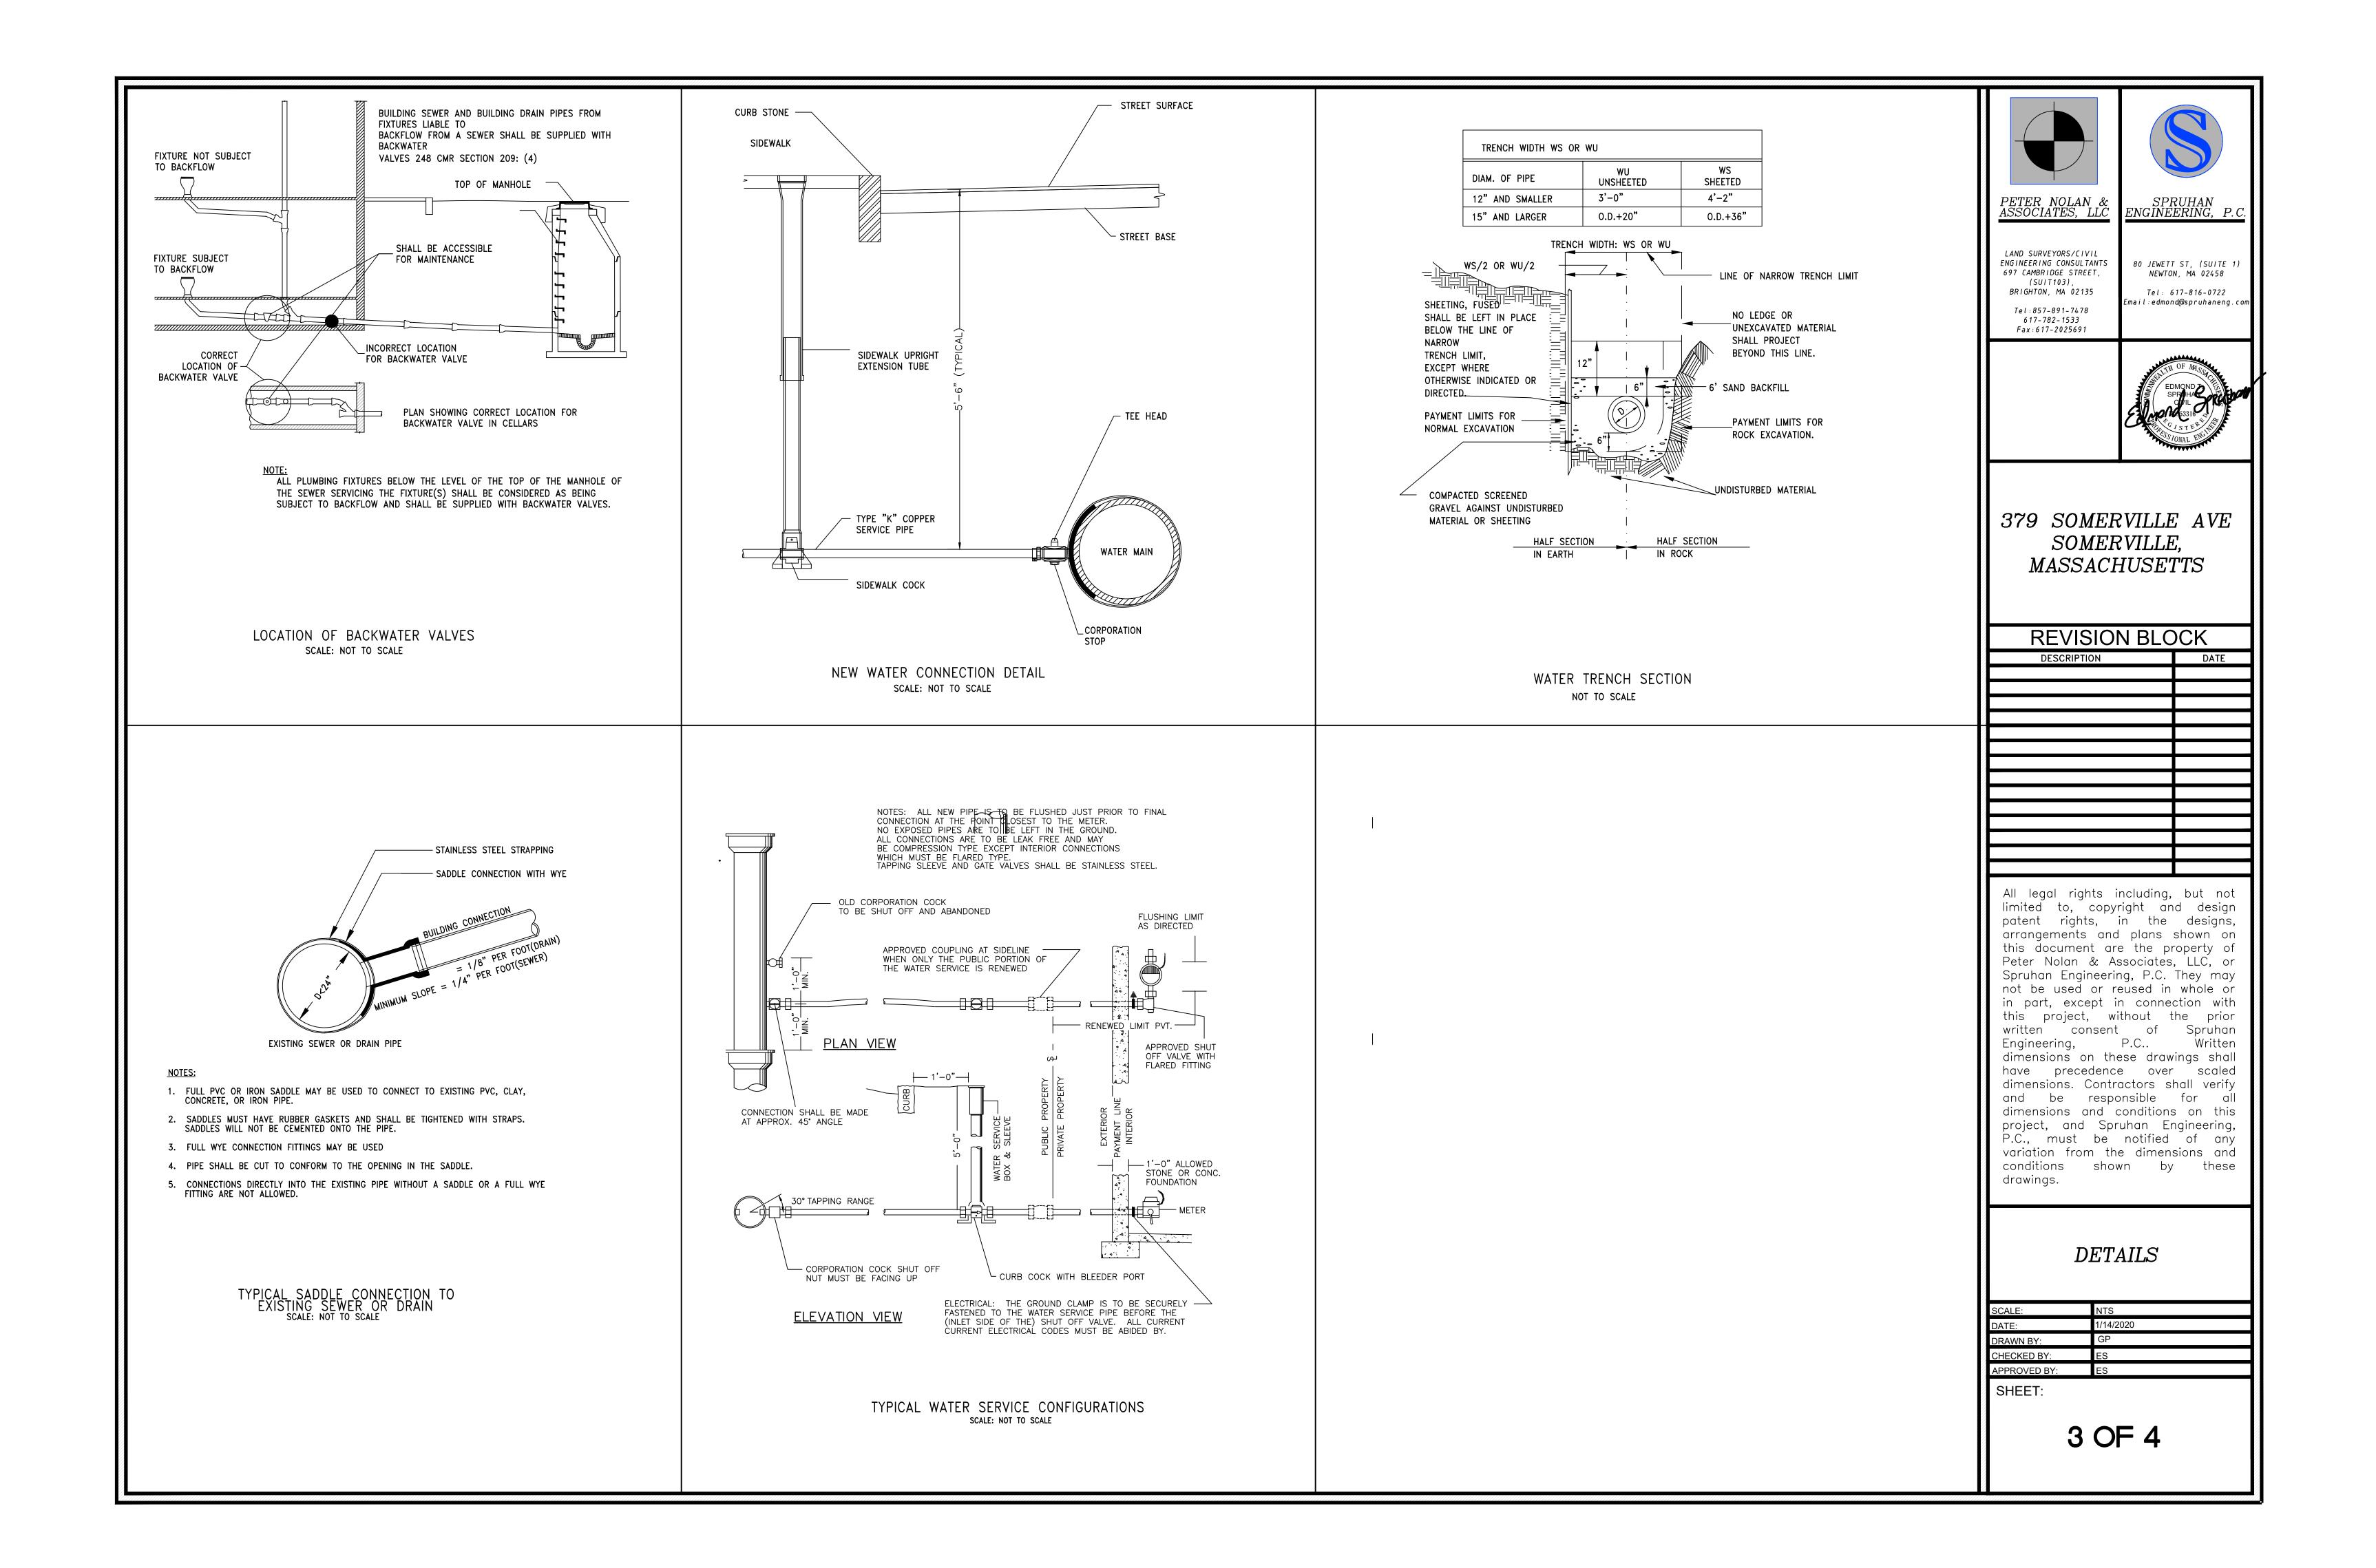

EROSION CONTROL NOTES

- 1. THE EROSION CONTROL PLANS IN THIS SET SHALL BE REVIEWED AND IMPLEMENTED BY THE CONTRACTOR PRIOR TO COMMENCEMENT OF WORK. CONTRACTOR SHALL WORK WITH THE PROJECT'S ENGINEER THROUGHOUT CONSTRUCTION TO ENSURE THE SITE IS PROPERLY PROTECTED FROM POSSIBLE POLLUTANTS. THE ENGINEER HAS AUTHORIZATION TO ADD OR REMOVE BMP MEASURES THROUGHOUT CONSTRUCTION.
- 2. THE CONTRACTOR SHALL BE RESPONSIBLE FOR IMPLEMENTING AND MAINTAINING SITE EROSION CONTROL AT ALL TIMES.
- 3. IT SHALL BE THE RESPONSIBILITY OF THE OWNER AND THE PERMITTEE TO ENSURE THAT EROSION DOES NOT OCCUR FROM ANY ACTIVITY DURING OR AFTER PROJECT CONSTRUCTION. ADDITIONAL MEASURES, BEYOND THOSE SPECIFIED, MAY BE REQUIRED BY THE PLANNING DIRECTOR AS DEEMED NECESSARY TO CONTROL ACCELERATED EROSION.
- 4. AT THE END OF EACH WORKDAY, AT THE END OF EACH WORKWEEK, THE CONTRACTOR SHALL IMPLEMENT ALL TEMPORARY MEASURES NECESSARY TO PREVENT EROSION AND SILTATION, UNTIL THE PROJECT HAS BEEN FINALIZED. THESE MEASURES SHALL INCLUDE, BUT NOT BE LIMITED TO, DIRECT SEEDING OF THE AFFECTED AREAS, STRAW MULCHING, AND/OR INSTALLATION OF STRAW BALES DAMS/SILT FENCES.
- 5. DURING CONSTRUCTION, NO TURBID WATER SHALL BE PERMITTED TO LEAVE THE SITE. USE OF SILT AND GREASE TRAPS, FILTER BERMS, HAY BALES OR SILT FENCES SHALL BE USED TO PREVENT SUCH DISCHARGE.
- 6. ALL AREAS ON— AND OFF-SITE EXPOSED DURING CONSTRUCTION ACTIVITIES, IF NOT PERMANENTLY LANDSCAPED PER PLAN, SHALL BE PROTECTED BY MULCHING AND/OR SEEDING.
- 7. ALL EXCAVATED MATERIAL SHALL BE REMOVED TO AN APPROVED DISPOSAL SITE OR DISPOSED OF ON-SITE IN A MANNER THAT WILL NOT CAUSE EROSION.
- 8. ANY MATERIAL STOCKPILED, FOR LONGER THAN 14 DAYS, DURING CONSTRUCTION SHALL BE COVERED WITH PLASTIC.
- 9. UPON COMPLETION OF CONSTRUCTION, ALL REMAINING EXPOSED SOILS SHALL BE PERMANENTLY REVEGETATED.
- 10. IT IS THE CONTRACTOR'S RESPONSIBILITY TO SEE THAT ADDITIONAL MEASURES NECESSARY TO CONTROL SITE EROSION AND PREVENT SEDIMENT TRANSPORT OFF-SITE ARE IMPLEMENTED.
- 11. ALL SPILLS AND/OR LEAKS SHALL BE IMMEDIATELY CLEANED UP AND MITIGATED.

CONSTRUCTION MATERIALS

- ALL LOOSE STOCKPILED CONSTRUCTION MATERIALS THAT ARE NOT ACTIVELY BEING USED (I.E. SOIL, SPOILS, AGGREGATE, FLY-ASH, STUCCO, HYDRATED LIME, ETC.) SHALL BE COVERED AND BERMED.
- ALL CHEMICALS SHALL BE STORED IN WATERTIGHT CONTAINERS (WITH APPROPRIATE SECONDARY CONTAINMENT TO PREVENT ANY SPILLAGE OR LEAKAGE) OR IN A STORAGE SHED (COMPLETELY ENCLOSED).
- BEST MANAGEMENT PRACTICES TO PREVENT THE OFF-SITE TRACKING OF LOOSE CONSTRUCTION AND LANDSCAPE MATERIALS SHALL BE IMPLEMENTED.

WASTE MANAGEMENT

- DISPOSAL OF ANY RINSE OR WASH WATERS OR MATERIALS ON IMPERVIOUS OR PERVIOUS SITE SURFACES OR INTO THE STORM DRAIN SYSTEM SHALL BE PREVENTED.
- SANITATION FACILITIES SHALL BE CONTAINED (E.G. PORTABLE TOILETS) TO PREVENT DISCHARGES OF POLLUTANTS TO THE STORM WATER DRAINAGE SYSTEM OR RECEIVING WATER, AND SHALL BE LOCATED A MINIMUM 20 FEET AWAY FROM AN INLET, STREET OR DRIVEWAY, STREAM, RIPARIAN AREA OR OTHER DRAINAGE FACILITY.
- SANITATION FACILITIES SHALL BE INSPECTED REGULARLY FOR LEAKS AND SPILLS AND CLEANED OR REPLACED AS NECESSARY.
- COVER WASTE DISPOSAL CONTAINERS AT THE END OF EVERY BUSINESS DAY AND DURING A RAIN EVENT.
- DISCHARGES FROM WASTE DISPOSAL CONTAINERS TO THE STORM WATER DRAINAGE SYSTEM OR RECEIVING WATER SHALL BE PREVENTED.
- STOCKPILED WASTE MATERIAL SHALL BE CONTAINED AND SECURELY PROTECTED FROM WIND AND RAIN AT ALL TIMES UNLESS ACTIVELY BEING USED.

PROCEDURES THAT EFFECTIVELY ADDRESS HAZARDOUS AND NON-HAZARDOUS SPILLS SHALL BE IMPLEMENTED.EQUIPMENT AND MATERIALS FOR CLEANUP OF SPILLS SHALL BE AVAILABLE ON SITE AND THAT SPILLS AND LEAKS SHALL BE CLEANED UP IMMEDIATELY AND DISPOSED OF PROPERLY; AND

• CONCRETE WASHOUT AREAS AND OTHER WASHOUT AREAS THAT MAY CONTAIN ADDITIONAL POLLUTANTS SHALL BE CONTAINED SO THERE IS NO DISCHARGE INTO THE UNDERLYING SOIL AND ONTO THE SURROUNDING AREAS.


SOSNA PETER S & QIONG LI TRUSTEES CHAINLINK **FENCE** FENCE · EXISTING SHED TO BE EXISTING SHED DEMOLISHED M.B.L 63/C/34 EXISTING PVC INSTALLED AROUND PERIMETER OF CONSTRUCTION (SEE DETAIL) IP PROPERTIES LLC PROPOSED FIBER ROLLS TO BE INSTALLED **EXISTING** AROUND PERIMETER OF BRICK CONSTRUCTION NOTE: CONTRACTOR WOOD FRAMED MAY HAVE TO ADJUST RESIDENTIAL LOCATION OF FIBER ROLLS AS DEMOLITION DWELLING PROGRESSES. F.F.=27.88 (TAKEN AT THRESHOLD) EXISTING S.M.H PROVIDE OPENING FOR CONSTRUCTION ENTRANCE AND EXIT WITH ANTI-TRACKING MEASURES (PREVENT SEDIMENT FROM LEAVING SITE APRX. LOCATION OF UNDERGROUND ELCETRIC EXISTING S.M.H. RIM = 27.19

VEHICLE STORAGE AND MAINTENANCE


- MEASURES SHALL BE TAKEN TO PREVENT OIL, GREASE, OR FUEL TO LEAK IN TO THE GROUND, STORM DRAINS OR SURFACE WATERS.
- ALL EQUIPMENT OR VEHICLES, WHICH ARE TO BE FUELED, MAINTAINED AND STORED ONSITE SHALL BE IN A DESIGNATED AREA FITTED WITH APPROPRIATE BMPs.
- LEAKS SHALL BE IMMEDIATELY CLEANED AND LEAKED MATERIALS SHALL BE DISPOSED OF PROPERLY.

LANDSCAPE MATERIALS


- CONTAIN STOCKPILED MATERIALS SUCH AS MULCHES AND TOPSOIL WHEN THEY ARE NOT ACTIVELY BEING USED
- CONTAIN FERTILIZERS AND OTHER LANDSCAPE MATERIALS WHEN THEY ARE NOT ACTIVELY BEING USED.
- DISCONTINUE THE APPLICATION OF ANY ERODIBLE LANDSCAPE MATERIAL WITHIN 2 DAYS BEFORE A FORECASTED RAIN EVENT OR DURING PERIODS OF PRECIPITATION.
- APPLY ERODIBLE LANDSCAPE MATERIAL AT QUANTITIES AND APPLICATION RATES ACCORDING TO MANUFACTURE RECOMMENDATIONS OR BASED ON WRITTEN SPECIFICATIONS BY KNOWLEDGEABLE AND EXPERIENCED FIELD PERSONNEL.
- STACK ERODIBLE LANDSCAPE MATERIAL ON PALLETS AND COVERING OR STORING SUCH MATERIALS WHEN NOT BEING USED OR APPLIED.

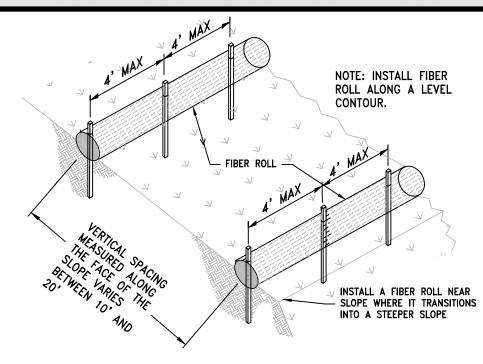

TYPICAL INSTALLATION

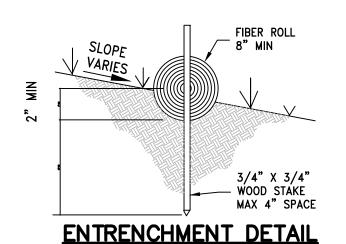

FIBER ROLLS

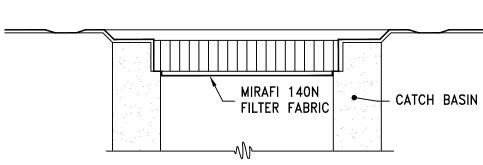

INSPECTION AND MAINTENANCE:

- 1. FILTER FABRIC BARRIERS SHALL BE INSPECTED WEEKLY AFTER EACH SIGNIFICANT STORM 1 INCH RAINFALL (25.4 MM) IN 24 HOUR PERIOD. ANY REQUIRED REPAIRS SHALL BE MADE IMMEDIATELY.
- 2. SEDIMENT SHOULD BE REMOVED WHEN IT REACHES 0.5" MAXIMUM HEIGHT. AT THAT TIME INSPECT THE FILTER MATERIAL FOR TEARS AND CLEAN OR REPLACE AS REQUIRED.
- 3. THE REMOVED SEDIMENT SHALL BE DISTRIBUTED EVENLY ACROSS AREAS ON-SITE, CONFORM WITH THE EXISTING GRADE AND BE REVEGETATED OR OTHERWISE STABILIZED PER EROSION CONTROL NOTES.

CATCH BASIN PROTECTION

FIBER ROLL CONSTRUCTION SPECIFICATIONS

- 1. PREPARE SLOPE BEFORE THE WATTLING PROCEDURE IS STARTED. SHALLOW GULLIES
- SHOULD BE SMOOTHED AS WORK PROGRESSES.

 2. DIG SMALL TRENCHES ACROSS SLOPE ON CONTOUR, TO PLACE WATTLES IN. THE TRENCH SHOULD BE DEEP ENOUGH TO ACCOMMODATE HALF THE THICKNESS OF THE WATTLE. WHEN THE SOIL IS LOOSE AND UNCOMPACTED, THE TRENCH SHOULD BE DEEP ENOUGH TO BURY THE WATTLE 2/3 OF ITS THICKNESS BECAUSE THE GROUND WILL SETTLE. IT IS CRITICAL THAT WATTLES ARE INSTALLED PERPENDICULAR TO WATER MOVEMENT, PARALLEL
- TO THE SLOPE CONTOUR.

 3. START BUILDING TRENCHES AND INSTALL WATTLES FROM THE BOTTOM OF THE SLOPE
- AND WORK UP.
 4. CONSTRUCT TRENCHES AT CONTOUR INTERVALS OF THREE TO EIGHT FEET APART
- DEPENDING ON STEEPNESS OF SLOPE. THE STEEPER THE SLOPE, THE CLOSER TOGETHER THE TRENCHES.

 5. LAY THE WATTLE ALONG THE TRENCHES FITTING IT SNUGLY AGAINST THE SOIL. MAKE
- SURE NO GAPS EXIST BETWEEN THE SOIL AND THE STRAW WATTLE. USE A STRAIGHT BAR TO DRIVE HOLES THROUGH THE WATTLE AND INTO THE SOIL FOR THE WOODEN STAKES.


 6. DRIVE THE STAKE THROUGH THE PREPARED HOLE INTO THE SOIL. LEAVE ONLY ONE OR
- TWO INCHES OF STAKE EXPOSED ABOVE WATTLE. IF USING WILLOW STAKES REFER TO USDA SOIL CONSERVATION SERVICE TECHNICAL GUIDE, BIOENGINEERING, FOR GUIDELINES TO PREPARING LIVE WILLOW MATERIAL.
- 7. INSTALL STAKES AT LEAST EVERY FOUR FEET APART THROUGH WATTLE. ADDITIONAL STAKES MAY BE DRIVEN ON THE DOWNSLOPE SIDE OF THE TRENCHES ON HIGHLY EROSIVE OR VERY STEEP SLOPES.


FIBER ROLL INSTALLATION AND MAINTENANCE

8. INSPECT THE STRAW WATTLE AND THE SLOPES AFTER SIGNIFICANT STORMS. MAKE SURE THE WATTLES ARE IN CONTACT WITH THE SOIL.

FIBER ROLLS

9. REPAIR ANY RILLS OR GULLIES PROMPTLY.
10. RESEED OR REPLANT VEGETATION IF NECESSARY UNTIL THE SLOPE IS STABILIZED.

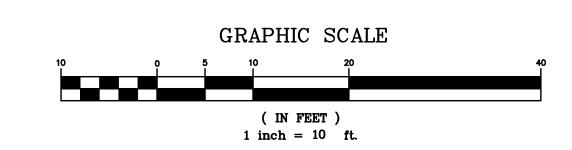

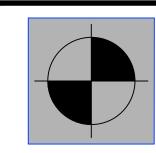



PETER NOLAN & ASSOCIATES, LLC

LAND SURVEYORS/CIVIL
ENGINEERING CONSULTANTS 80 J
697 CAMBRIDGE STREET,
(SUIT103),
BRIGHTON, MA 02135 T
Email:

80 JEWETT ST, (SUITE 1) NEWTON, MA 02458 Tel: 617-816-0722 Email:edmond@spruhaneng.co

SPRUHAN ENGINEERING, P.C.



617-782-1533

Fax:617-2025691



379 SOMERVILLE AVE SOMERVILLE, MASSACHUSETTS


REVISION BLC)CK
DESCRIPTION	DATE

All legal rights including, but not limited to, copyright and design patent rights, in the designs, arrangements and plans shown on this document are the property of Peter Nolan & Associates, LLC, or Spruhan Engineering, P.C. They may not be used or reused in whole or in part, except in connection with this project, without the prior written consent of Spruhan dimensions on these drawings shall have precedence over scaled dimensions. Contractors shall verify and be responsible for dimensions and conditions on this project, and Spruhan Engineering, P.C., must be notified of any variation from the dimensions and conditions shown by these drawings.

DEMOLITION & EROSION CONTROL PLAN

SCALE:	1" = 10'
DATE:	1/14/2020
DRAWN BY:	GP
CHECKED BY:	ES
APPROVED BY:	ES
SHEET:	

4 OF 4

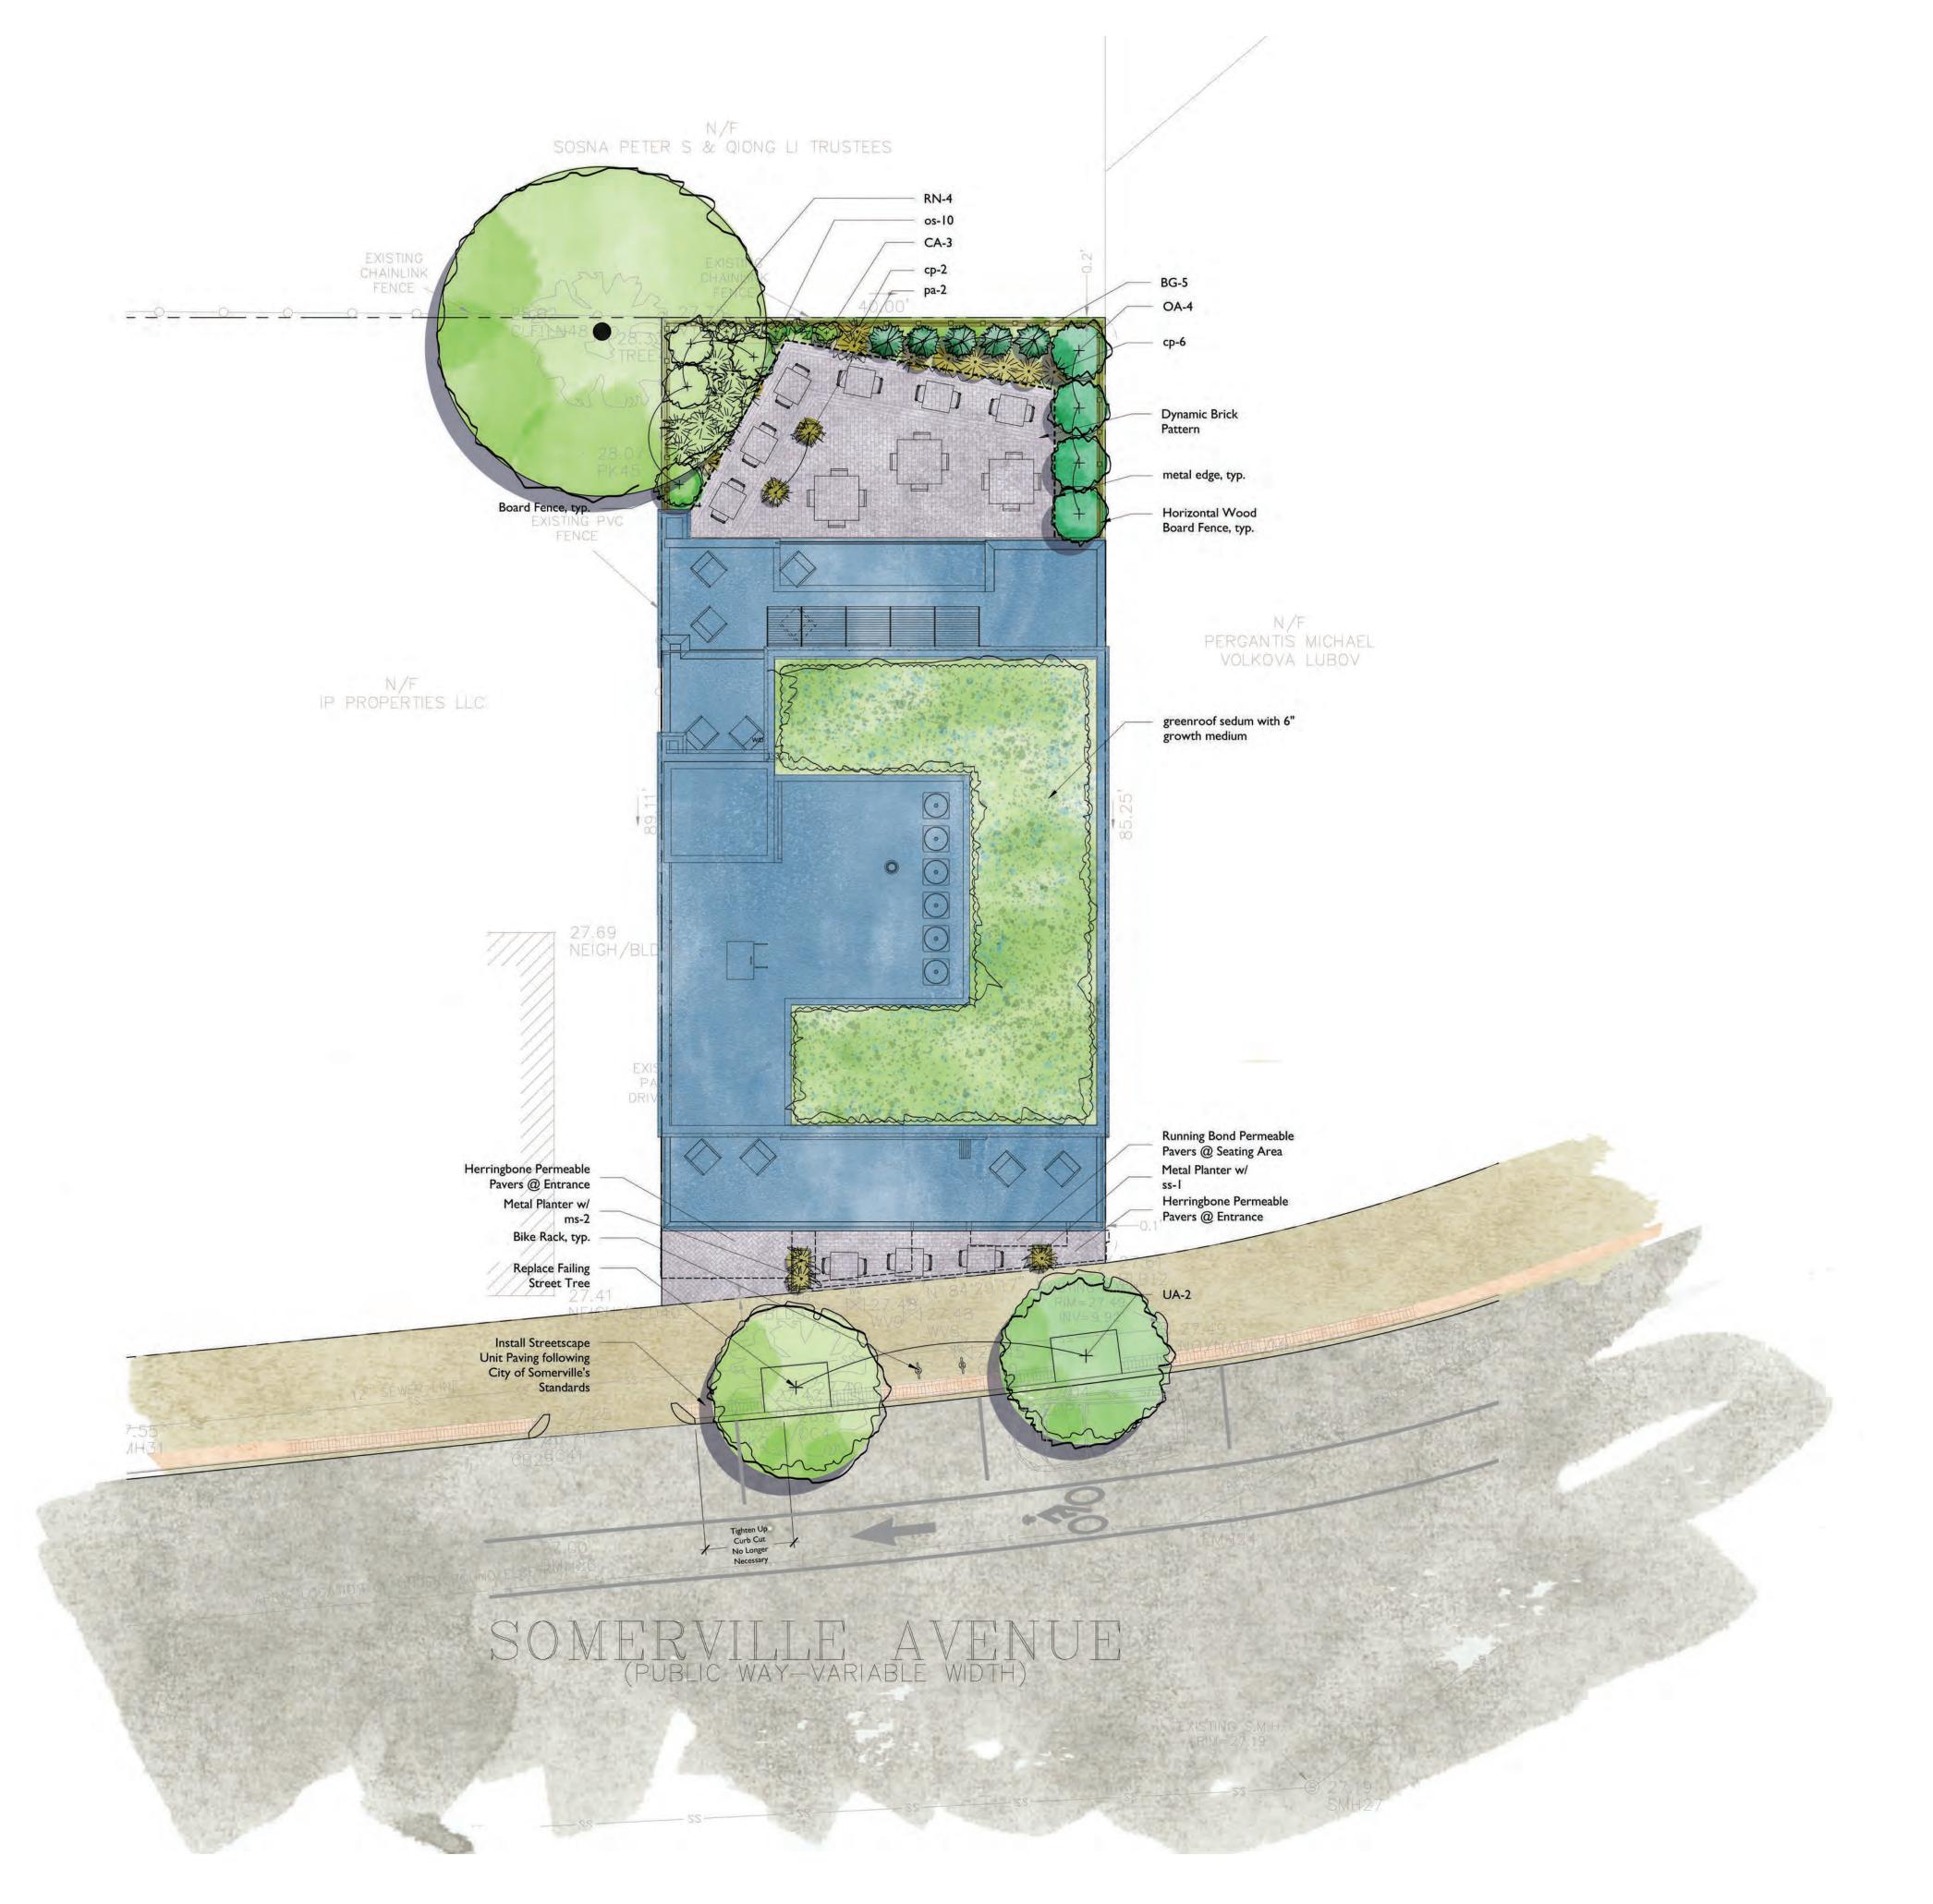

PROPO	SED PI	LANT LIST			
SYMBC	QTY.	LATIN NAME	COMMON NAME	SIZE	NOTES
OA	4	Oxydendrum arboreum	Sourwood	2-3" cal.	B&B, native, ≥ 2' ht
UA	2	Ulmus americana	American Elm 'Valley Forge'	2.5-3.0" cal.	B&B, ≥ 2' ht.
SHRUB	NV & 2	NES			
BG	5	Buxus 'Green Mountain'	Green Mountain Boxwood	30-36" ht.	Pots, \geq 2' ht.
CA	3	Clethra alnifolia	Sweet Pepperbush	2 gal.	Pots, native, ≥ 2' ht
RN	4	Rhododendron 'Nova Zembla'	Rhododendron	3 gal.	Pots, ≥ 2' ht
HERBA	CEOUS	S			
ср	8	Carex pennsylvanica	Sedge	2 gal.	Pots, native, ≤ 2' ht
os	10	Osmundastrum cinnamoneum	Cinnamon Fern	l gal.	Pots, native, ≥ 2' ht
ms	2	Miscanthus sinesis 'Little Zebra'	Little Maiden Grass	l gal.	Pots, \geq 2' ht.
ра	2	Polystichum acrostichoides	Christmas Fern	l gal.	Pots, native, ≤ 2' ht
SS	- 1	Schizachyrium scoparium	Little Bluestem	l gal.	Pots, native, ≥ 2' ht

PLANTING NOTES

- 1. Existing plants shall be pruned by an Arborist or Nurseryman knowledgeable about growth characteristics of the species of plantsto remain.
- 2. Remove invasive trees, except Chinese Elm as noted.
- 3. All plant material shall conform to the guidelines established by "The American Standard for Nursery Stock", published by the American Association of Nurserymen, Inc.
- 4. The rootballs of trees shall be planted 3" above adjacent finished grade. Excavate holes no deeper than the rootball of trees. Holes shall be at least 3' greater in diameter than root ball. Backfill planting hole with 'planting mix'. All plants which settle out of plumb or below finished grade shall be immediately replanted.
- 5. The rootballs of shrubs shall be planted 2" above adjacent finished grade. Excavate holes no deeper than the rootball of shrubs.
- 6. All potted plants shall have the rootballs scarified prior to planting to cut encircling roots.
- 7. All shrubs, groundcovers and perennials shall be planted in continuous planting beds. All beds shall be excavated 12" and the topsoil and subsoil set aside for reuse. Remove all stone and debris from excavated soil. Backfill beds with 12" of 'planting mix' before planting shrubs, perennials and groundcovers.
- 8. 'Planting Mix' shall consist of 2 parts of topsoil saved from site excavations and 1 part compost. Thoroughly mix to create uniform blended mixture. If insufficient topsoil is available on the site, mix existing soil in a ratio of 1 part soil to 1 part compost. Remove all stones and debris larger than 2" from planting mix.
- 9. All plants are to be thoroughly watered after installation, at least twice within the first 24 hours.

IRRIGATION NOTES

1. Intensive green roofs shall have an irrigation system.









6' Horizontal Wood Board Fence



Blended Brick Paving




Planters



Miscanthus sinensis 'Little Zebra'



Ostrich Fern Matteuccia struthiopteris

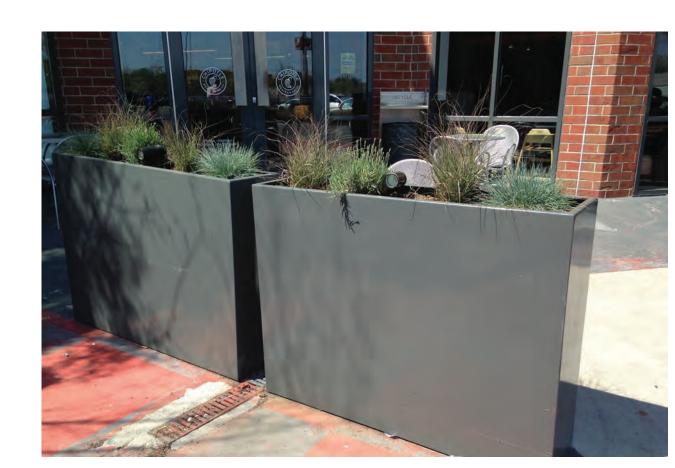

Planters



American Elm Ulmus Americana



Little Bluestem Schizachyrium scoparium



Cinnamon Fern
Osmundastrum cinnamoneum



Sourwood Oxydendrum arboreum



Carex Carex pennsylvanica



Buxus 'sempervirens



Rhododendron



Clethra alnifolia Sweet Pepperbush



Polystichum acrostichoides Christmas Fern





PROJECT NAME

THUNDER ROAD

PROJECT ADDRESS

379 Somerville Ave Somerville, MA

CLIENT

379 SOMERVILLE AVE, LLC

ARCHITECT



17 IVALOO STREET SUITE 400 SOMERVILLE, MA 02143 TELEPHONE: 617-591-8682 FAX: 617-591-2086

CONSULTANTS:

NOTE:

THIS PROJECT RECEIVED

BOARD ON 7.21.20

THE HISTORIC PRESERVATION

PERMISSION TO BE DEMOLISHED BY

COPYRIGHT KDI © 2019
THESE DRAWINGS ARE NOW AND DO
REMAIN THE SOLE PROPERTY OF KHALSA
DESIGN INC. USE OF THESE PLANS OR ANY
FORM OF REPRODUCTION OF THIS DESIGN IN WHOLE OR IN PART WITHOUT EXPRESS WRITTEN CONSENT IS PROHIBITED AND SHALL RESULT IN THE FULLEST EXTENT


REGISTRATION

OF PROSECUTION UNDER LAW


Project n	ımber		1904 ⁻
Date		5	/18/202
Drawn by			ASE
Checked	by		JSł
Scale		1/8	8" = 1'-0
REVISI	ONS		
No.	Description		Date

DEMO Plans & Elevations

THUNDER ROAD

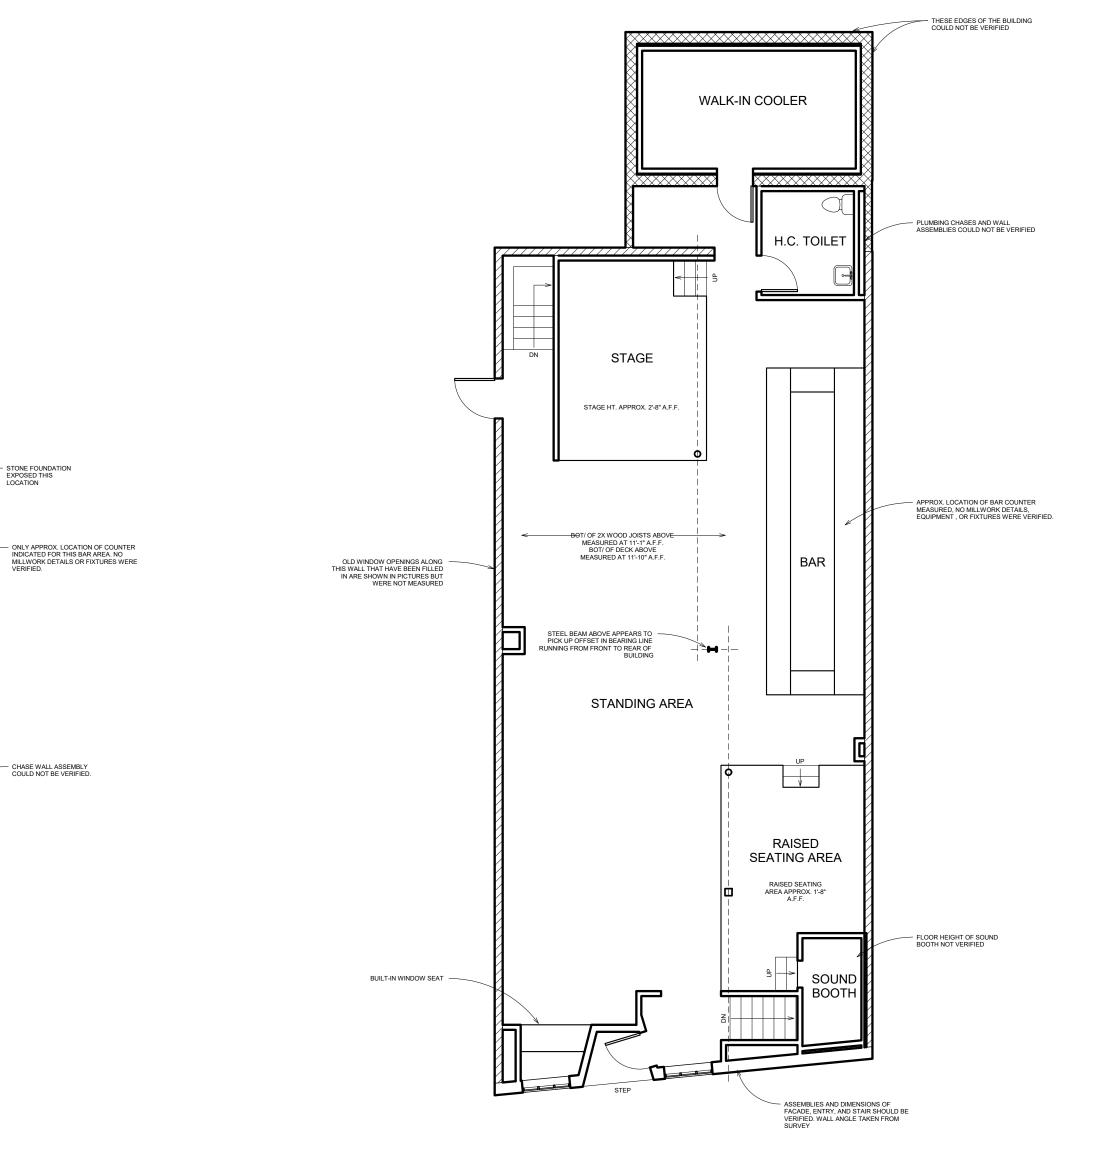

FIRST FLOOR PLAN

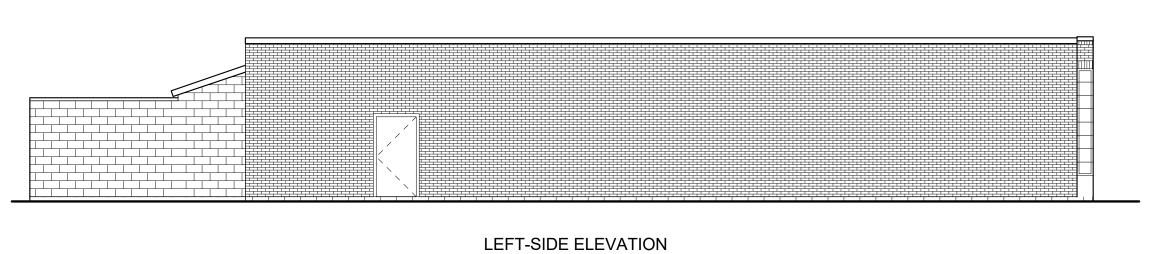

BASEMENT PLAN

OFFICE

WALK-IN COOLER

KITCHEN


STANDING AREA

CHASE WALL ASSEMBLY COULD NOT BE VERIFIED.

1) EXISTING CONDITIONS 1/8" = 1'-0"

FOUNDATION WALL ASSEMBLIES UNCONFIRMED UNLESS NOTES OTHERWISE



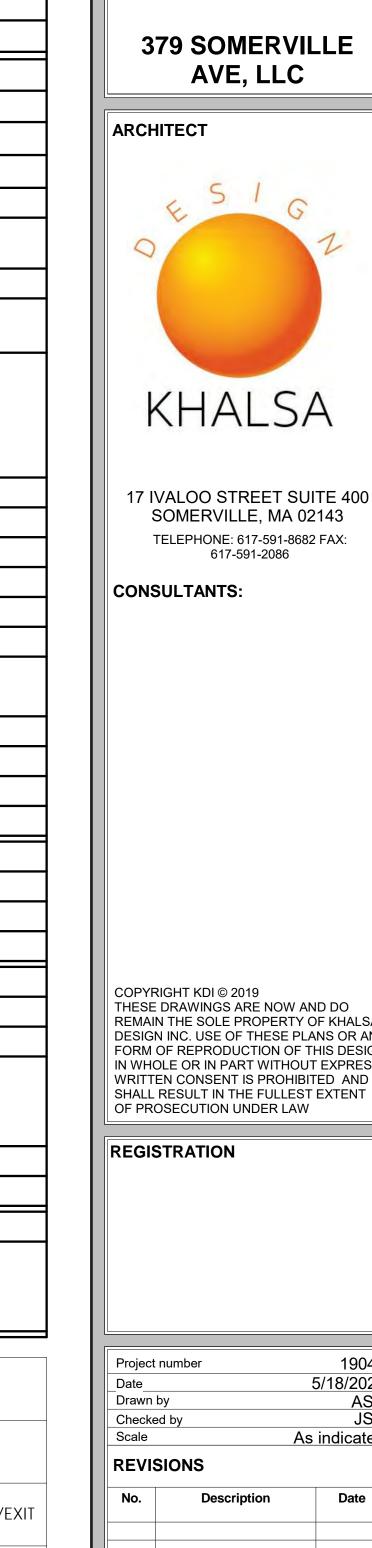

ZONING DIMENSIONAL: LOT SIZE: 3487.20 SF COMMENTS ALLOWED / REQUIRED PROPOSED MR5 ZONE ZONE MR5 ZONE **BUILDING TYPE** GENERAL BUILDING GENERAL BUILDING LOT DIMENSIONS WIDTH (MIN.) 30 FT 40.19 COMPLIES LOT DEVELOPMENT LOT COVERAGE (MAX) 76.6% / 2671 SF COMPLIES GREEN FACTOR (MIN.) 0.25 MIN 0.30 IDEAL COMPLIES COMPLIES OPEN SPACE 23.4% **BUILDING SETBACKS** 1'-5 3/8" @ GRADE / COMPLIES PRIMARY FRONT (MIN/ MAX.) 2 FT / 12 FT 3'-4" AT BAYS SECONDARY FRONT (MIN/ MAX.) 2 FT / 12 FT COMPLIES @ ALLEY OR ROW: 0 FT COMPLIES SIDE (MIN) 1" (R) / 0 FT (L) @ NR OR LHD: 10'-0" @ ALLEY OR ROW: 10 FT REAR (MIN) 20'-0" FLOORS 1-3 ABUTTING NR 1st- 3rd: 10 FT COMPLIES ABUTTING NR 4th-5th: 30 FT 30'-0"" FLOORS 4-5 **MAIN BODY** BUILDING WIDTH (MAX.) 200 FT COMPLIES 40'-0" FACADE BUILD OUT, FRONT STREET (MIN.) 80 % PRIMARY FRONT COMPLIES 100% SECONDARY FRONT 65 % NOT APPLICABLE COMPLIES 15,000 SF 2570 SF COMPLIES FLOOR PLATE (MAX.) 3 STORIES BUILDING HEIGHT, STORIES (MIN.) COMPLIES 5 STORIES GROUND STORY HEIGHT (MIN.) 14 FT 14 FT COMPLIES UPPER STORY HEIGHT (MIN.) 10 FT 10'-6" FT COMPLIES BUILDING HEIGHT, FEET (MAX.) 62 FT 54'-1" FT COMPLIES **ROOF TYPE** FLAT FLAT COMPLIES **FACADE COMPOSITION** 48% (231 SF / 483 SF) COMPLIES GROUND STORY FENESTRATION (MIN./MAX.) 15% / 50% UPPER STORY FENESTRATION (MIN./ MAX.) 15% / 50% 36% (151 SF / 420 SF) COMPLIES 20 FT BLANK WALL (MAX.) COMPLIES **USE & OCCUPANCY** GROSS FLOOR AREA PER DU LOT AREA < 5,000 SF 1,500 3,487 LOT AREA > 5,000 SF COMPLIES NET ZERO BUILDING 3487 x 4 / 850 (16.4 DU) 10 DU 100% AFFORDABLE COMPLIES PROVIDED OUTDOOR AMENITY SPACE (MIN.) 1/ DU PARKING (RESIDENTIAL) (1) SPACES COMPLIES MIN SHORT TERM BICYCLE PARKING 0.1/DU (1.0 SPACES) 1 /DU (10 SPACES) MIN LONG TERM BICYCLE PARKING 10 SPACES MAXIMUM PARKING (WITHIN TRANSIT AREA) 1/DU (10 SPACES **MAX**) 0 SPACES

COM	1PLIES	
LEGE	IND	
	USEABLE OPEN SPACE	EXISTING BUILDING
	PROPOSED BUILDING FOOTPRINT	BUILDING ENTRANCE/EXIT MARKER
	PAVED AREA	
	SETBACK LINE	
	PROPOERTY LINE	

SMALL TREE/SHURBS AT

PERIMETER FENCING

NEW WOOD FENCE

A-300 3

RESIDENTAL **ENTRANCE**

BASEMENT

LINE OF BALCONY & **BAY PROJECTION**

1 SITE PLAN 3/16" = 1'-0"

EXIT

ABOVE

ELEV.

---+-/4

---/

A-300

GREEN SPACE 791 SF

40'-0"

COMMERCIAL

TENANT FIT UP

GENERAL

BUILDING

COMMERCIAL ENTRANCE

> **EXISTING STREET** TREE TO REMAIN

SETBACK LINE 1ST - 3RD FLOOR

SETBACK LINE 4th - 5th FLOOR

INDIVIDUAL PLANT

6 SF x 18 = 108 SF

LINE OF BALCONY

ABOVE

4 A-300

LOT COVERAGE BUILDING

2525 SF

RESIDENTIAL EXIT

LOT COVERAGE

ABOVE 146 SF

155 SF

OVERHANG & BAY

PERVIOUS PAVERS

STAIR E

—— 12FT SETBACK FROM STREET CURB—

AREA = 6 SF

LEGEN	ND	
	USEABLE OPEN SPACE	EXISTING BUILDING
	PROPOSED BUILDING FOOTPRINT	BUILDING ENTRANCE/EXIT MARKER
	PAVED AREA	
	SETBACK LINE	
	PROPOERTY LINE	

PROJECT NAME

THUNDER ROAD

PROJECT ADDRESS

379 Somerville Ave Somerville, MA

CLIENT

379 SOMERVILLE AVE, LLC




17 IVALOO STREET SUITE 400 SOMERVILLE, MA 02143 TELEPHONE: 617-591-8682 FAX: 617-591-2086

THESE DRAWINGS ARE NOW AND DO REMAIN THE SOLE PROPERTY OF KHALSA DESIGN INC. USE OF THESE PLANS OR ANY FORM OF REPRODUCTION OF THIS DESIGN IN WHOLE OR IN PART WITHOUT EXPRESS WRITTEN CONSENT IS PROHIBITED AND

Project nu	ımber	190
Date		5/18/20
Drawn by		A
Checked I	by	J.
Scale		As indicat
REVISION	ONS	
No.	Description	Date
1		

ARCHITECTURAL SITE PLAN

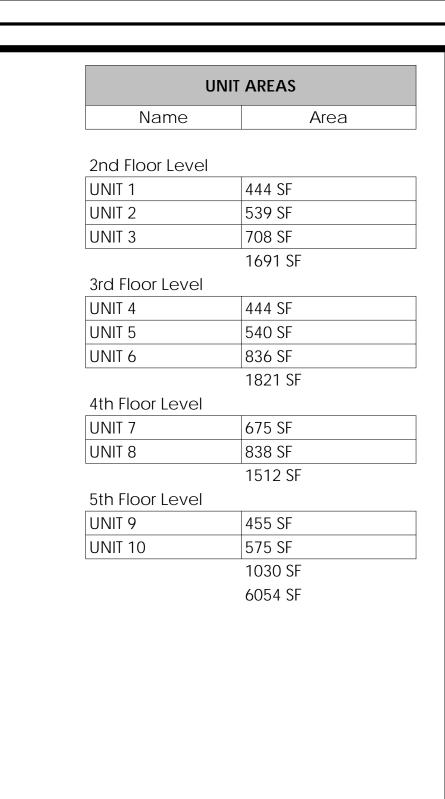



ELEV.

CORRIDOR

288 SF

2 1st Floor Level 1/8" = 1'-0"

RES. BIKE STORAGE

ELEV. MACH. RM

ELEV.

SPRINKLER RM

1 Basement Level 1/8" = 1'-0"

COMMERCIAL

TRASH

MECH./ ELE¢

COMMERCIAL 1893 SF

THUNDER ROAD

PROJECT NAME

PROJECT ADDRESS 379 Somerville Ave Somerville, MA

CLIENT

379 SOMERVILLE AVE, LLC

ARCHITECT



17 IVALOO STREET SUITE 400 SOMERVILLE, MA 02143 TELEPHONE: 617-591-8682 FAX: 617-591-2086

CONSULTANTS:

COPYRIGHT KDI © 2019
THESE DRAWINGS ARE NOW AND DO
REMAIN THE SOLE PROPERTY OF KHALSA
DESIGN INC. USE OF THESE PLANS OR ANY
FORM OF REPRODUCTION OF THIS DESIGN IN WHOLE OR IN PART WITHOUT EXPRESS WRITTEN CONSENT IS PROHIBITED AND SHALL RESULT IN THE FULLEST EXTENT

REGISTRATION

Project	number	19041
Date	,	5/18/2021
Drawn	by	ASB
Checke	ed by	JSK
Scale	1.	/8" = 1'-0"
REVI	SIONS	
No.	Description	Date
		<u> </u>

UNIT AREA CALC.

5/18/2021 Author Checker

1/8" = 1'-0"


REVISIONS

Description

AVE, LLC

BUILDING AREA THUNDER ROAD



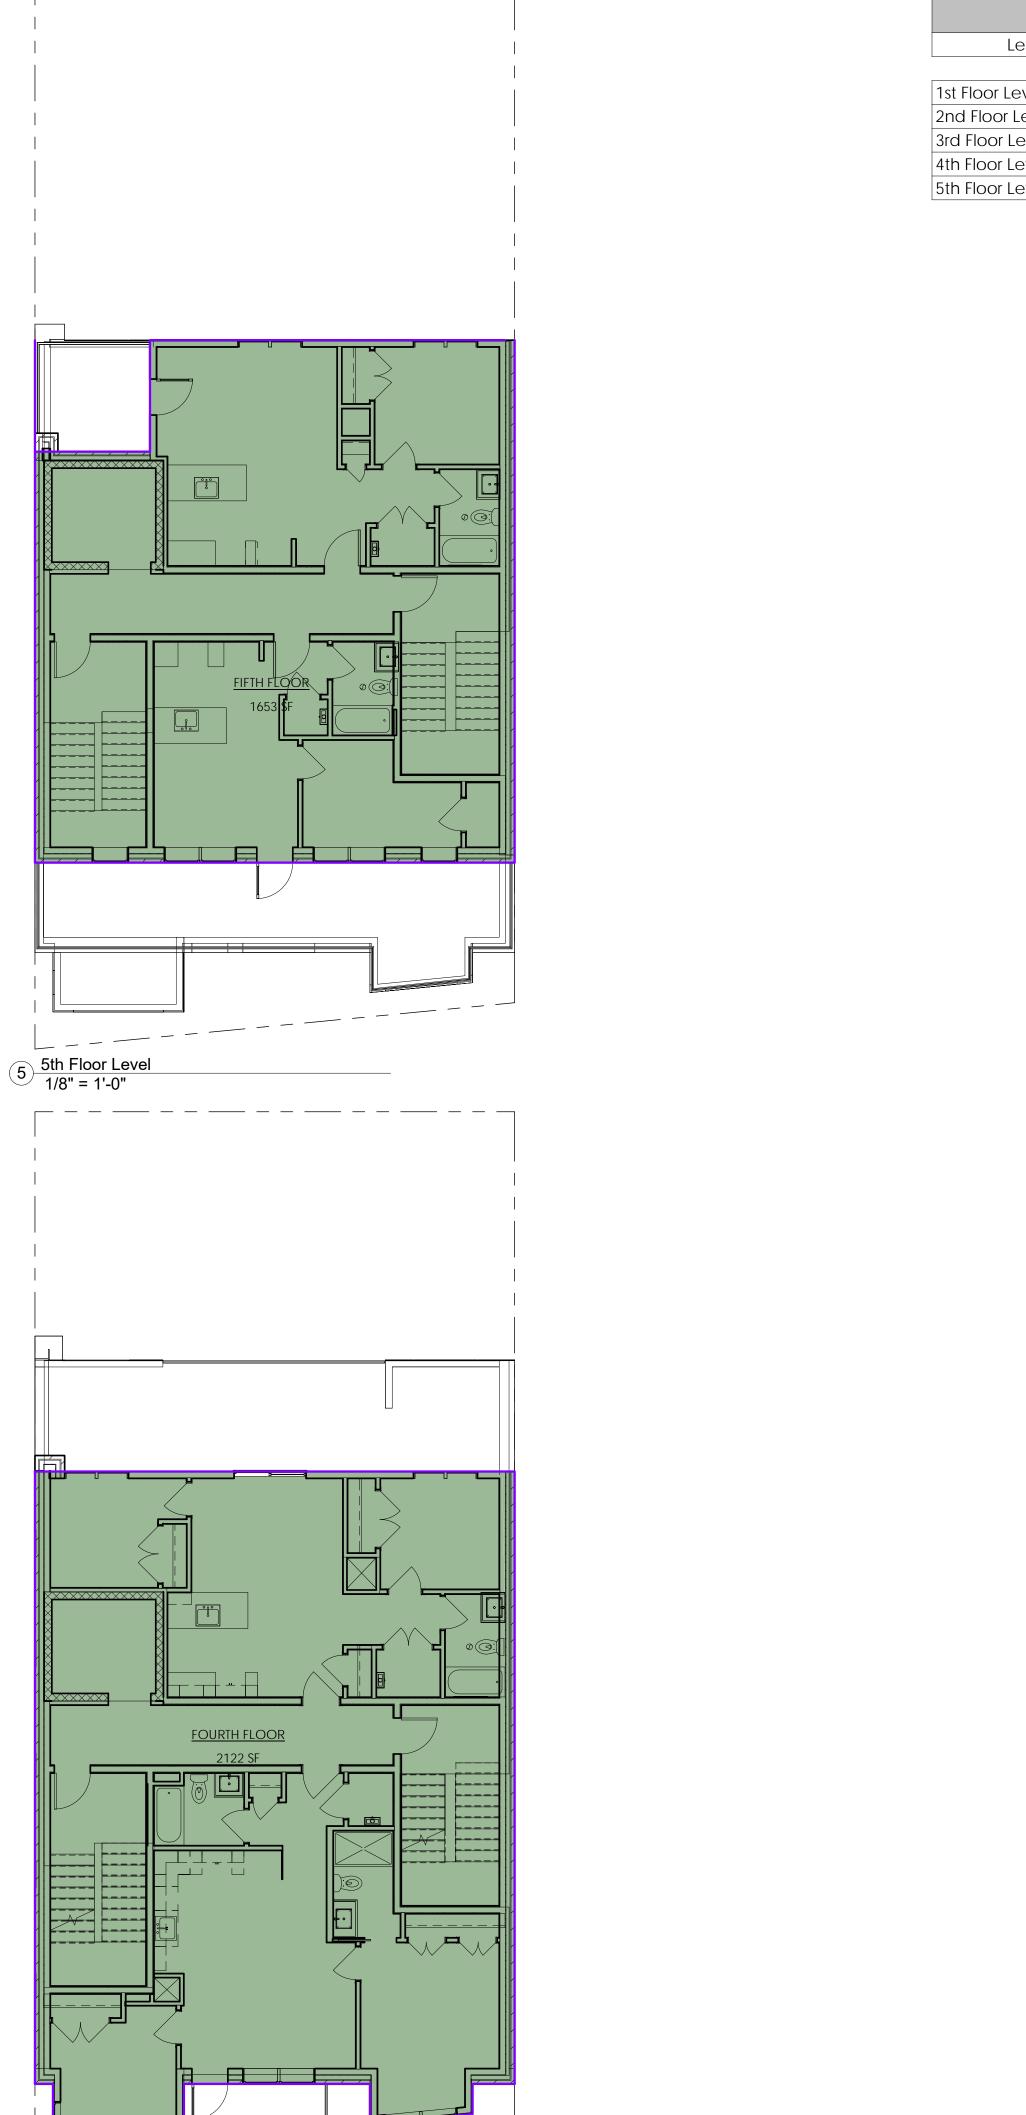

GROUND FLOOR 2525 SF

BASEMENT FLOOR

2510 SF

1 1st Floor Level 1/8" = 1'-0"

6 Basement Level 1/8" = 1'-0"


SECOND FLOOR

2376 SF

4th Floor Level
1/8" = 1'-0"

3 3rd Floor Level 1/8" = 1'-0"

2 2nd Floor Level 1/8" = 1'-0"

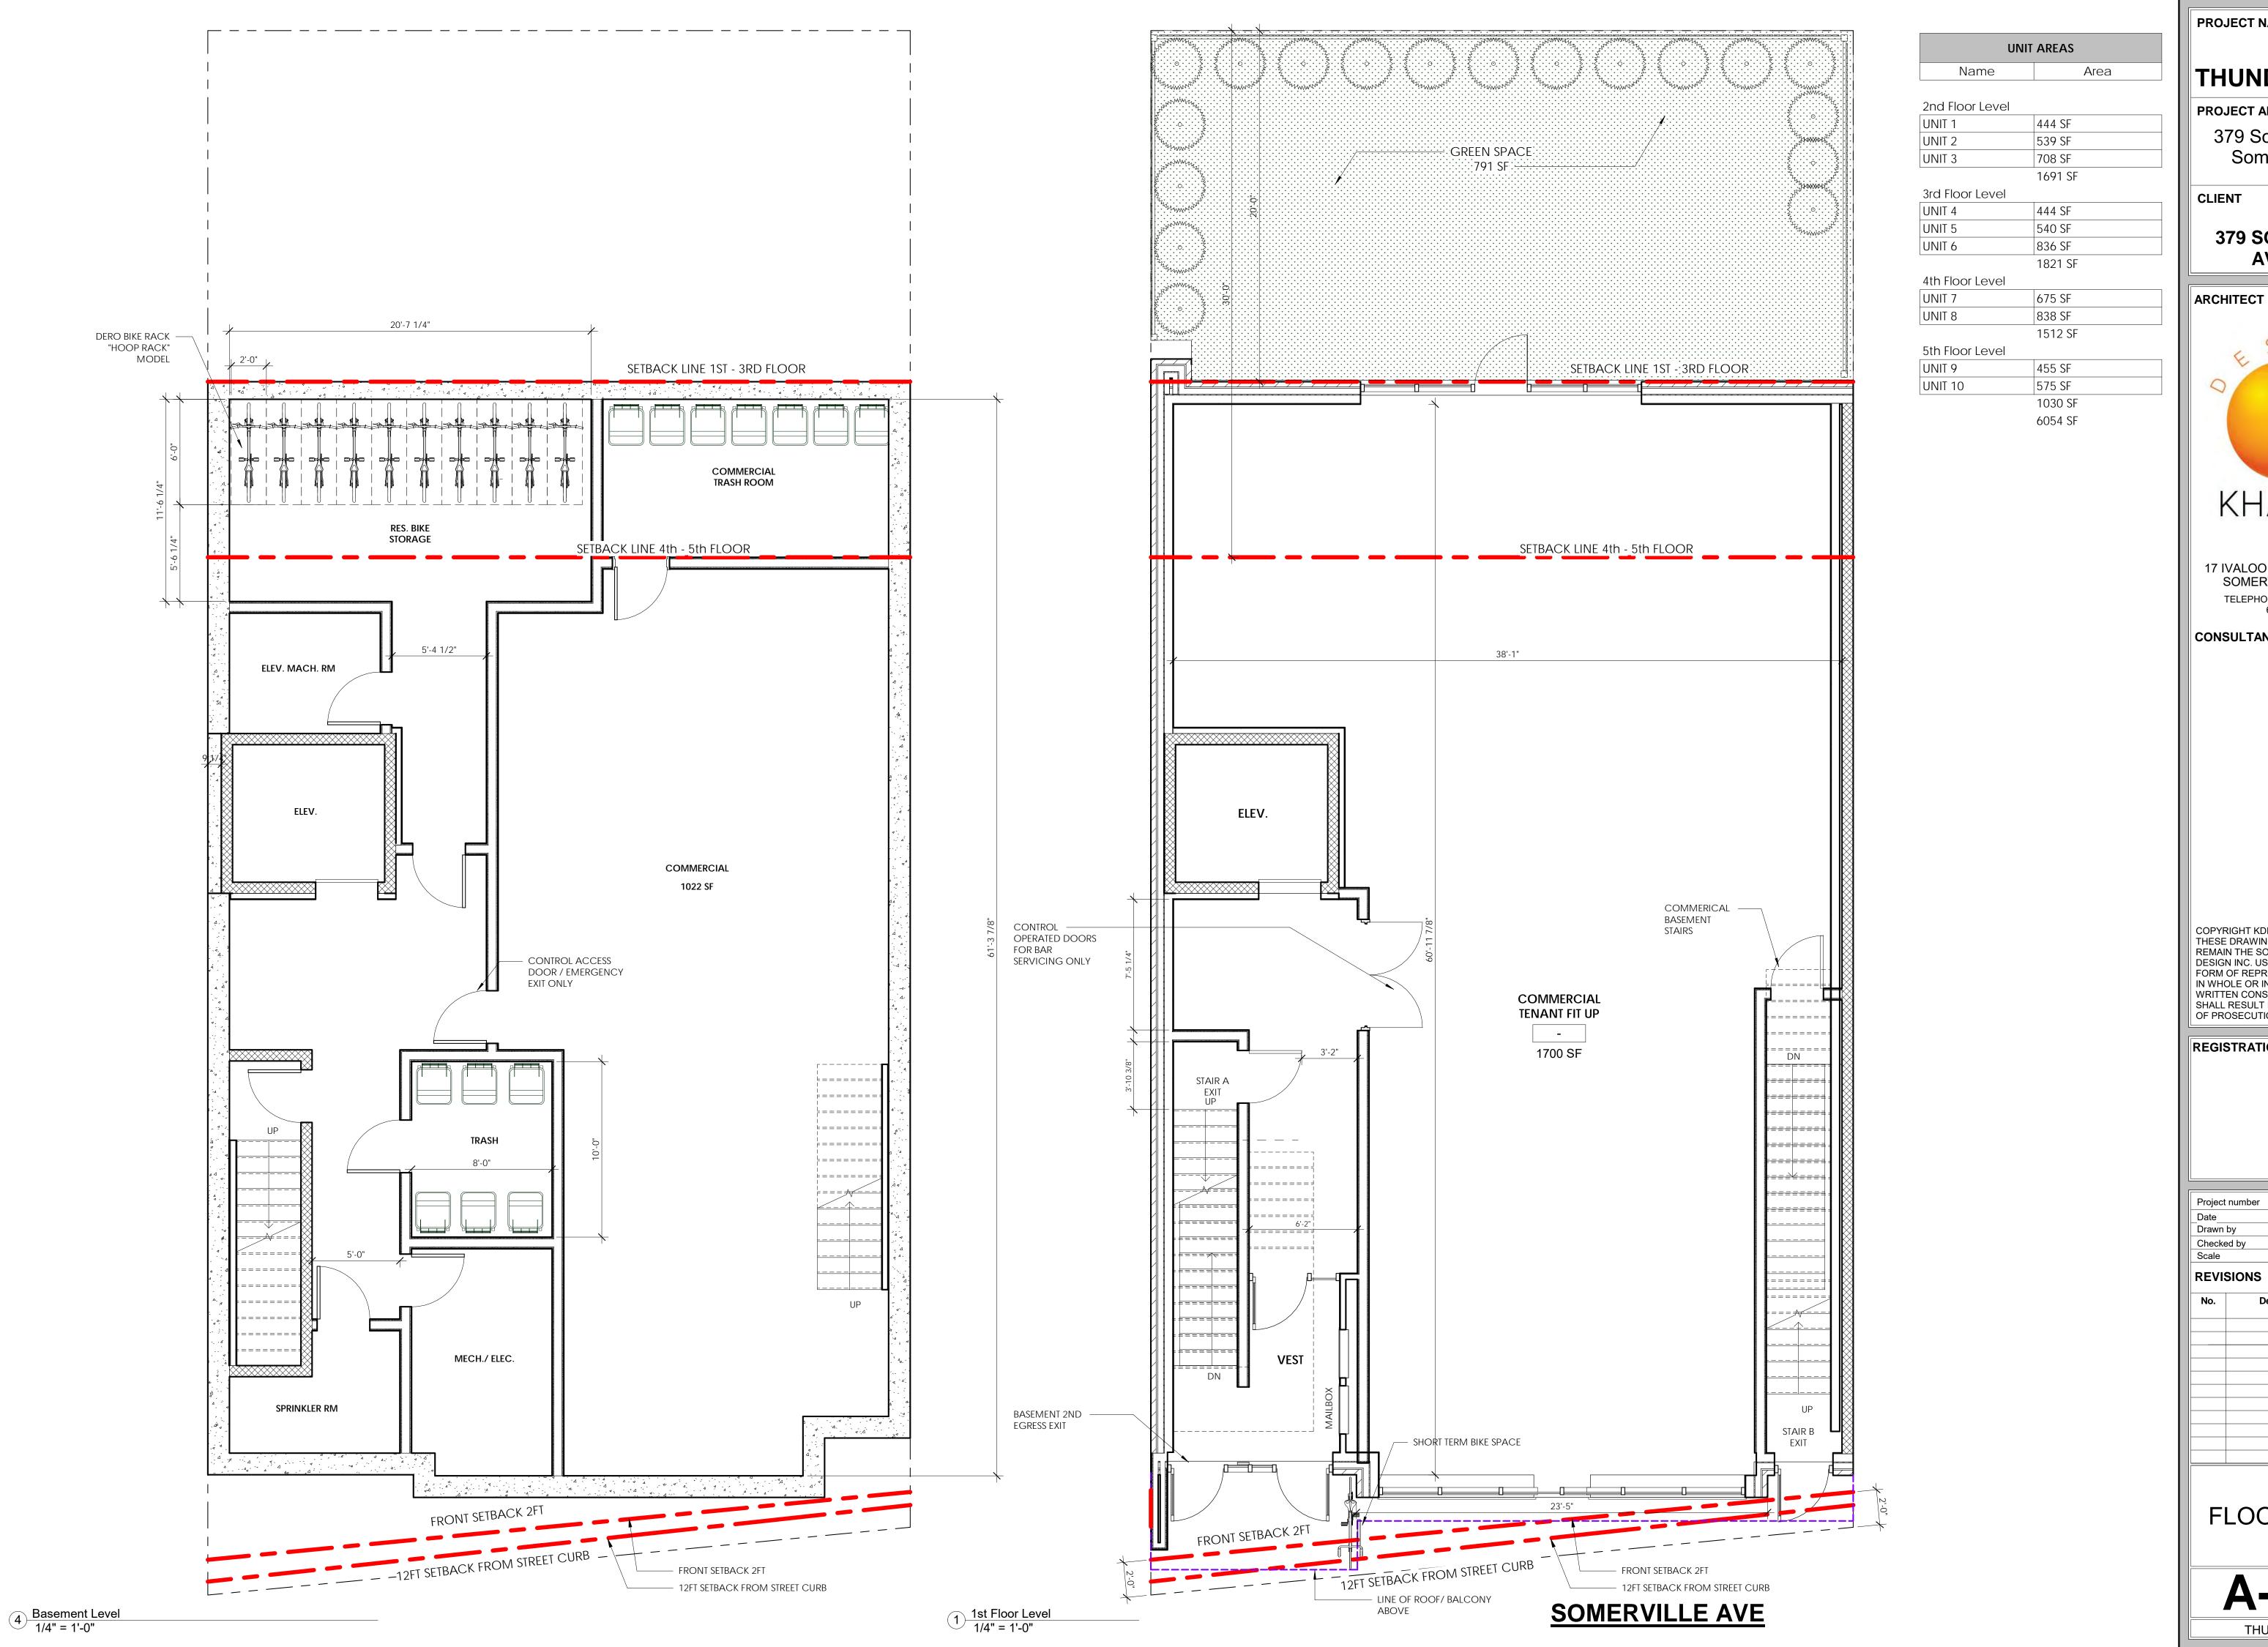

PROJECT NAME

THUNDER ROAD

PROJECT ADDRESS

379 Somerville Ave Somerville, MA

379 SOMERVILLE AVE, LLC



17 IVALOO STREET SUITE 400 SOMERVILLE, MA 02143 TELEPHONE: 617-591-8682 FAX: 617-591-2086

CONSULTANTS:

COPYRIGHT KDI © 2019 THESE DRAWINGS ARE NOW AND DO REMAIN THE SOLE PROPERTY OF KHALSA DESIGN INC. USE OF THESE PLANS OR ANY IN WHOLE OR IN PART WITHOUT EXPRESS WRITTEN CONSENT IS PROHIBITED AND SHALL RESULT IN THE FULLEST EXTENT OF PROSECUTION UNDER LAW

REGISTRATION

Project number 1904		19041
Date		5/18/2021
Drawn by		ASB
Checked by		JSK
Scale		1/4" = 1'-0"
REVISION	S	
No.	Description	Date
		-

FLOOR PLANS

PROJECT NAME

THUNDER ROAD


PROJECT ADDRESS

379 Somerville Ave Somerville, MA

CLIENT

379 SOMERVILLE AVE, LLC

ARCHITECT

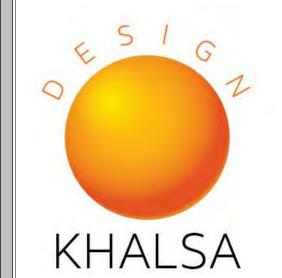

17 IVALOO STREET SUITE 400 SOMERVILLE, MA 02143 TELEPHONE: 617-591-8682 FAX: 617-591-2086

CONSULTANTS:

COPYRIGHT KDI © 2019
THESE DRAWINGS ARE NOW AND DO
REMAIN THE SOLE PROPERTY OF KHALSA
DESIGN INC. USE OF THESE PLANS OR ANY
FORM OF REPRODUCTION OF THIS DESIGN
IN WHOLE OR IN PART WITHOUT EXPRESS
WRITTEN CONSENT IS PROHIBITED AND
SHALL RESULT IN THE FULLEST EXTENT
OF PROSECUTION UNDER LAW

REGISTRATION

Project	number	19041	
Date		5/18/2021	
Drawn	by	ASB	
Checke	ed by	JSK	
Scale		1/4" = 1'-0"	
REVI	SIONS		
No.	Description	Date	
		ll l	

FLOOR PLANS

A-102
THUNDER ROAD

1 4th Floor Level 1/4" = 1'-0" PROJECT NAME

THUNDER ROAD

PROJECT ADDRESS

379 Somerville Ave Somerville, MA

CLIENT

379 SOMERVILLE AVE, LLC

ARCHITECT



17 IVALOO STREET SUITE 400 SOMERVILLE, MA 02143 TELEPHONE: 617-591-8682 FAX: 617-591-2086

CONSULTANTS:


COPYRIGHT KDI © 2019
THESE DRAWINGS ARE NOW AND DO
REMAIN THE SOLE PROPERTY OF KHALSA
DESIGN INC. USE OF THESE PLANS OR ANY
FORM OF REPRODUCTION OF THIS DESIGN
IN WHOLE OR IN PART WITHOUT EXPRESS
WRITTEN CONSENT IS PROHIBITED AND
SHALL RESULT IN THE FULLEST EXTENT
OF PROSECUTION UNDER LAW

REGISTRATION

Project r	number	19041	
Date		5/18/2021	
Drawn b	у	ASB	
Checked	d by	JSK	
Scale		1/4" = 1'-0"	
REVIS	IONS		
No.	Description	Date	

FLOOR PLANS


A-103
THUNDER ROAD

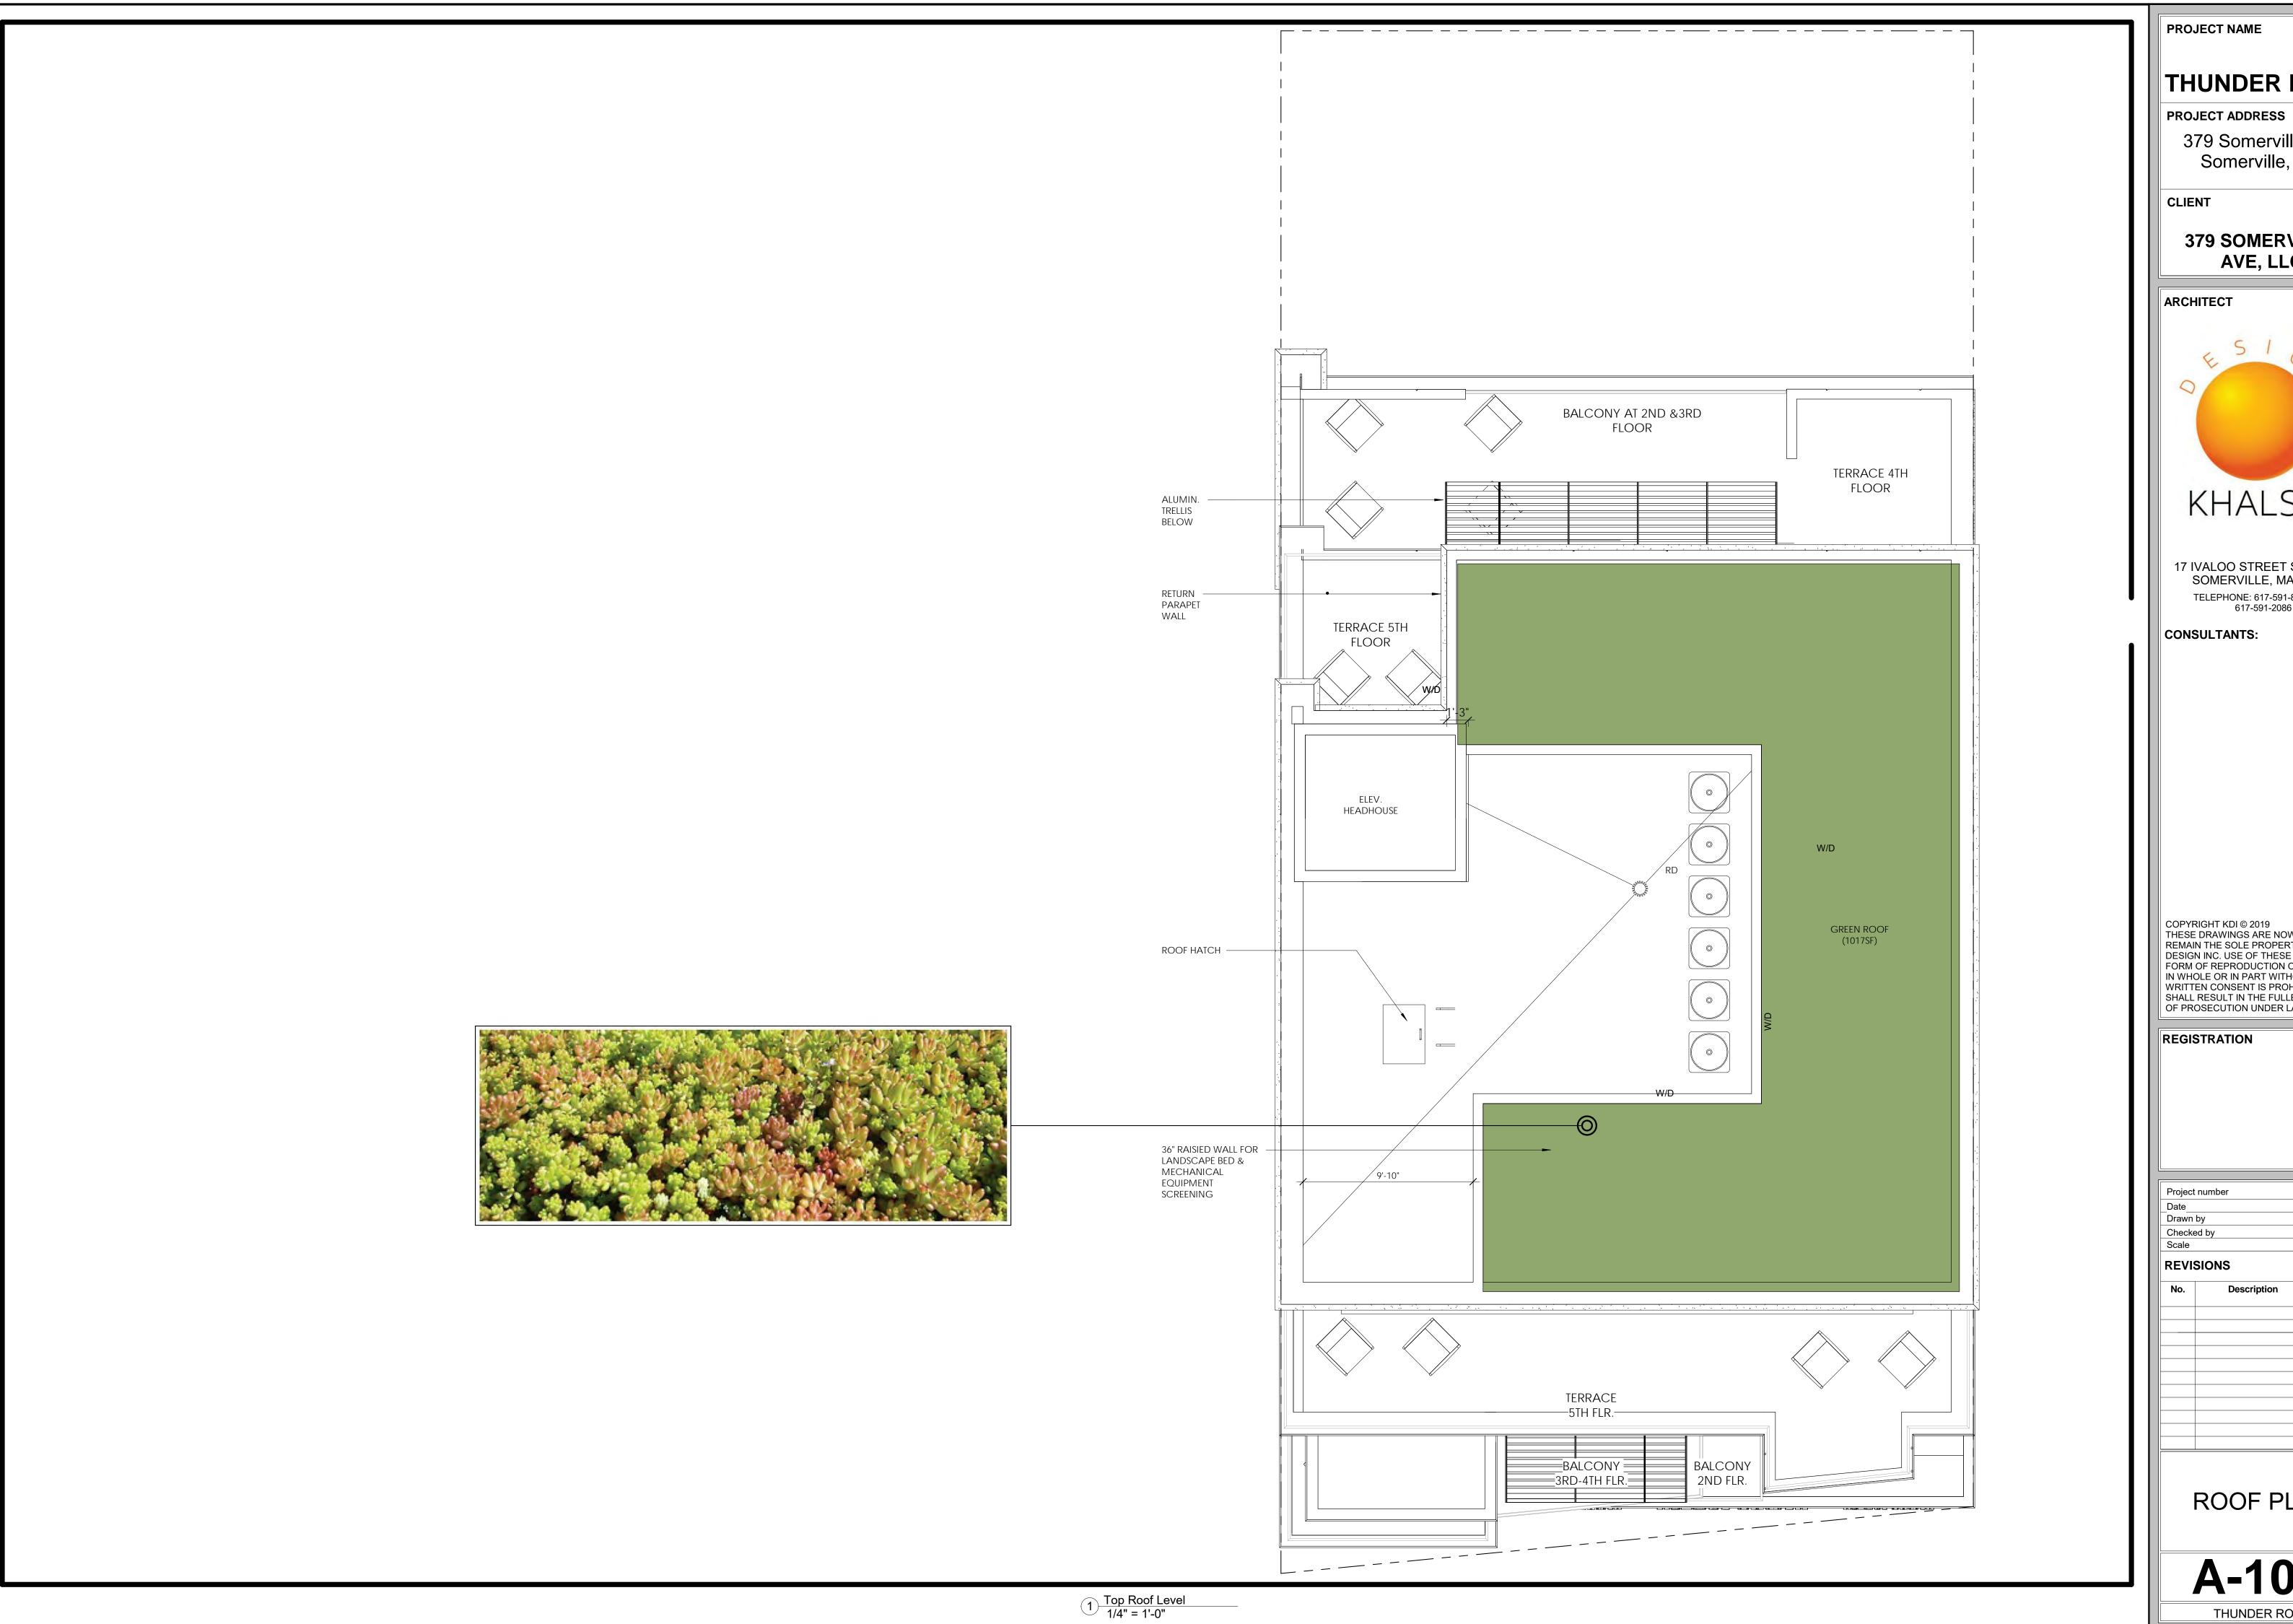

THUNDER ROAD

379 Somerville Ave Somerville, MA

379 SOMERVILLE AVE, LLC

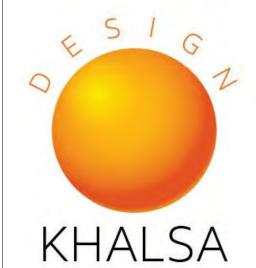

17 IVALOO STREET SUITE 400 SOMERVILLE, MA 02143 TELEPHONE: 617-591-8682 FAX: 617-591-2086

CONSULTANTS:

COPYRIGHT KDI © 2019
THESE DRAWINGS ARE NOW AND DO
REMAIN THE SOLE PROPERTY OF KHALSA
DESIGN INC. USE OF THESE PLANS OR ANY
FORM OF REPRODUCTION OF THIS DESIGN
IN WHOLE OR IN PART WITHOUT EXPRESS WRITTEN CONSENT IS PROHIBITED AND SHALL RESULT IN THE FULLEST EXTENT OF PROSECUTION UNDER LAW

mber	1904	
	5/18/2021	
	ASB	
у	JSK	
	1/4" = 1'-0	
ONS		
Description	Date	
	Description	

ROOF PLAN



Top Roof Level 56' - 0"


st Floor Level 0' - 0"

2 REAR ELEVATION
1/8" = 1'-0"

1st Floor Level 0' - 0"



Top Roof Level 56' - 0"

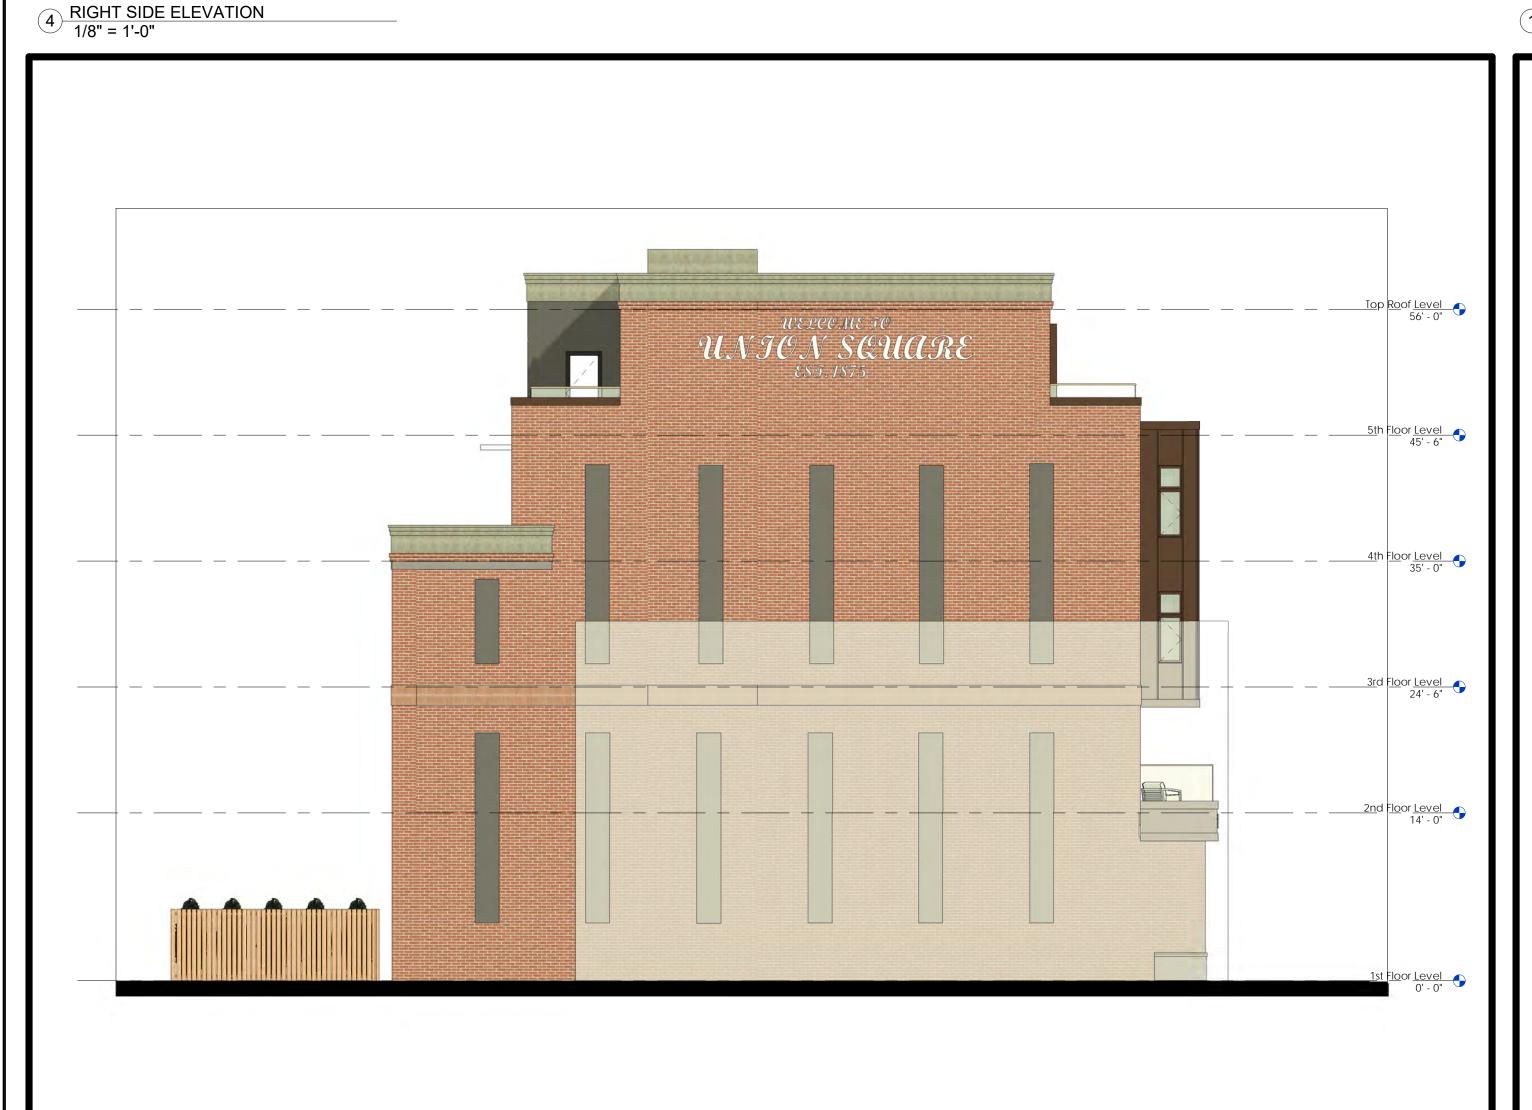



CLIENT

PROJECT NAME

PROJECT ADDRESS

THUNDER ROAD

379 Somerville Ave

Somerville, MA

EXTERIOR MATERIALS

FULL BRICK EXTERIOR

ANODIZED BRONZE ALUMINUM INSULATED

PRECAST CORNICE

TYPICAL EXTERIOR

CEMENTITIOUS PANELS BY CEMBRIT. COLOR:

WALL SCONCE

GRANITE

PANELS

Project nu	umber	19041
Date		5/18/2021
Drawn by		ASE
Checked	by	JSK
Scale		1/8" = 1'-0'
REVISI	ONS	
No.	Description	Date

EXTERIOR ELEVATIONS


A-300 THUNDER ROAD

3 LEFT SIDE ELEVATION 1/8" = 1'-0"

2nd Floor Level 14' - 0"

1<u>st Floor Level</u> 0' - 0"

ARCHITECT

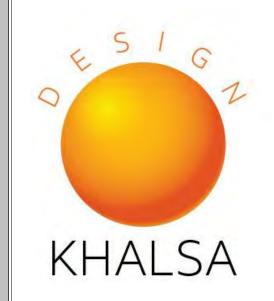

17 IVALOO STREET SUITE 400 SOMERVILLE, MA 02143 TELEPHONE: 617-591-8682 FAX: 617-591-2086

CONSULTANTS:

COPYRIGHT KDI © 2017 THESE DRAWINGS ARE NOW AND DO REMAIN THE SOLE PROPERTY OF KHALSA DESIGN INC. USE OF THESE PLANS OR ANY FORM OF REPRODUCTION OF THIS DESIGN IN WHOLE OR IN PART WITHOUT EXPRESS WRITTEN CONSENT IS PROHIBITED AND SHALL RESULT IN THE FULLEST EXTENT

REGISTRATION

Project number

OF PROSECUTION UNDER LAW



,			
Date		5	/18/2021
Drawn by			Autho
Checked	by		Checke
Scale		As	indicated
REVISI	ONS		
No.	Description		Date

FASCADE CALC. & SIGN PLANS

> **A-302** THUNDER ROAD



1 SIGN ELEVATION 3/8" = 1'-0"

WINDOW SIGN PERMITTED SIZES: PROVIDED: Area (max) 20% of Glass Width (max) 5'-0" 2'-0 1/2" Height (max) 3'-0" LETTERING: Height (max) 18"

COMMERCIAL WALL SIGN

PROVIDED:

25 SQ FT

1'-3 3/4"

TBD

TBD

TBD

TBD

19'-3 1/2" (69%)

1 COMMERCIAL SIGN

PROVIDED:

3.51 SQ FT

1'-3 3/4"

TBD

TBD

TBD

TBD

1 RESIDENTIAL SIGN

90% of Facade width 7'-4 7/8" (19%)

PERMITTED SIZES:

Width (max)

Width (max)

LOCATION:

PERMITTED SIZES:

Width (max)

Width (max)

LOCATION:

LETTERING:

Area (max) 40 SQ FT.

Height (min/max) 1ft / 4 ft

LETTERING:

Area (max) 40 SQ FT.

Height (min/max) 1ft / 4 ft

90% of Facade width

75% of Sign width

75% of Sign width

Height (max) 75% of Sign height

Projection from Facade (max)

Number of Signs 1 per Tenant

Raceway Height (max)

Height (max) 75% of Sign height

Projection from Facade (max)

Number of Signs 1 per Tenant

RESIDENTIAL WALL SIGN

Raceway Height (max)

TYPICAL STORY TOTAL WALL AREA = 420 SF GLAZING AREA = 134 SF RATIO = 32 %

GROUND STORY TOTAL WALL AREA GLAZING AREA = 70.3 %

RATIO

5th Floor Level 45' - 6" 4th Floor Level 35' - 0" 3rd Floor Level 24' - 6" 2nd Floor Level 14' - 0" --STORE NAME-- --STORE NAME-379

= 560 SF = 394 SF

2 FACADE COMPOSITION CALCULATIONS
3/16" = 1'-0"



WHAT WE HEARD....

...TOP FLOOR LOOKS LIKE A CYCLOPS...

...PRE-PATINA COPPER IS BRIGHT...

...OFFSET WINDOWS AND LACK OF SYMMETRY IS JARRING...

...WINDOWS ARE INCONSISTENT IN SIZE AND STYLE...

...PROJECT IS A BORING BOX WITH BAYS...

WHAT WE REVISED....

ADDED WINDOWS TO TOP FLOOR TO PROVIDE SYMMETRY AND CONNECTED TOP FLOOR TO LOWER FLOORS

REMOVED COPPER PANELS AND REPLACED WITH A SUBDUED ANNODIZED ALUMINUM PANEL IN A BRONZE FINISH.

REVISED BAY PROJECTIONS AND ENLARGED BALCONY'S TO GIVE A SYMMETRICAL LOOK.

WINDOW STYLE IS NOW CONSISTENT AND UNIFIES THE BUILDING.

ABIDING BY THE LIMITS OF ZONING THE FRONT FACADE HAS BEEN REVISED TO CREATE A WARMER, RICHER APPEARANCE THAT IS BOTH CONTEMPORARY AND ELEGANT WHILE REFERENCING THE ARCHITECTURAL RHYTHYM AND STYLE OF EXISTING SOMERVILLE ARCHITECTURE.

PROJECT NAME


THUNDER ROAD

PROJECT ADDRESS

379 Somerville Ave Somerville, MA

CLIENT

379 SOMERVILLE AVE, LLC

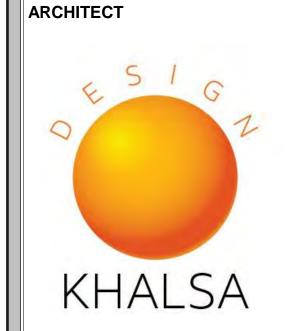


17 IVALOO STREET SUITE 400 SOMERVILLE, MA 02143

CONSULTANTS:

COPYRIGHT KDI © 2017 THESE DRAWINGS ARE NOW AND DO REMAIN THE SOLE PROPERTY OF KHALSA


REGISTRATION

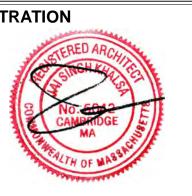

Project nu	umber	19041
Date		5/18/2021
Drawn by		Author
Checked	by	Checker
Scale		3/8" = 1'-0"
REVISI	ONS	
No.	Description	Date

Facade Revisions

A-303 THUNDER ROAD

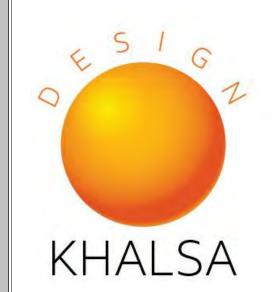

17 IVALOO STREET SUITE 400 SOMERVILLE, MA 02143 TELEPHONE: 617-591-8682 FAX: 617-591-2086

CONSULTANTS:

COPYRIGHT KDI © 2019
THESE DRAWINGS ARE NOW AND DO
REMAIN THE SOLE PROPERTY OF KHALSA
DESIGN INC. USE OF THESE PLANS OR ANY
FORM OF REPRODUCTION OF THIS DESIGN
IN WHOLE OR IN PART WITHOUT EXPRESS WRITTEN CONSENT IS PROHIBITED AND SHALL RESULT IN THE FULLEST EXTENT OF PROSECUTION UNDER LAW

REGISTRATION

Project nu	ımber	19041
Date		5/18/2021
Drawn by		ASB
Checked I	by	JSK
Scale		
REVISION	ONS	
No.	Description	Date

PERSPECTIVES






(2) 3D View 2 1 3D View 1



(4) 3D View 4

3 3D View 3

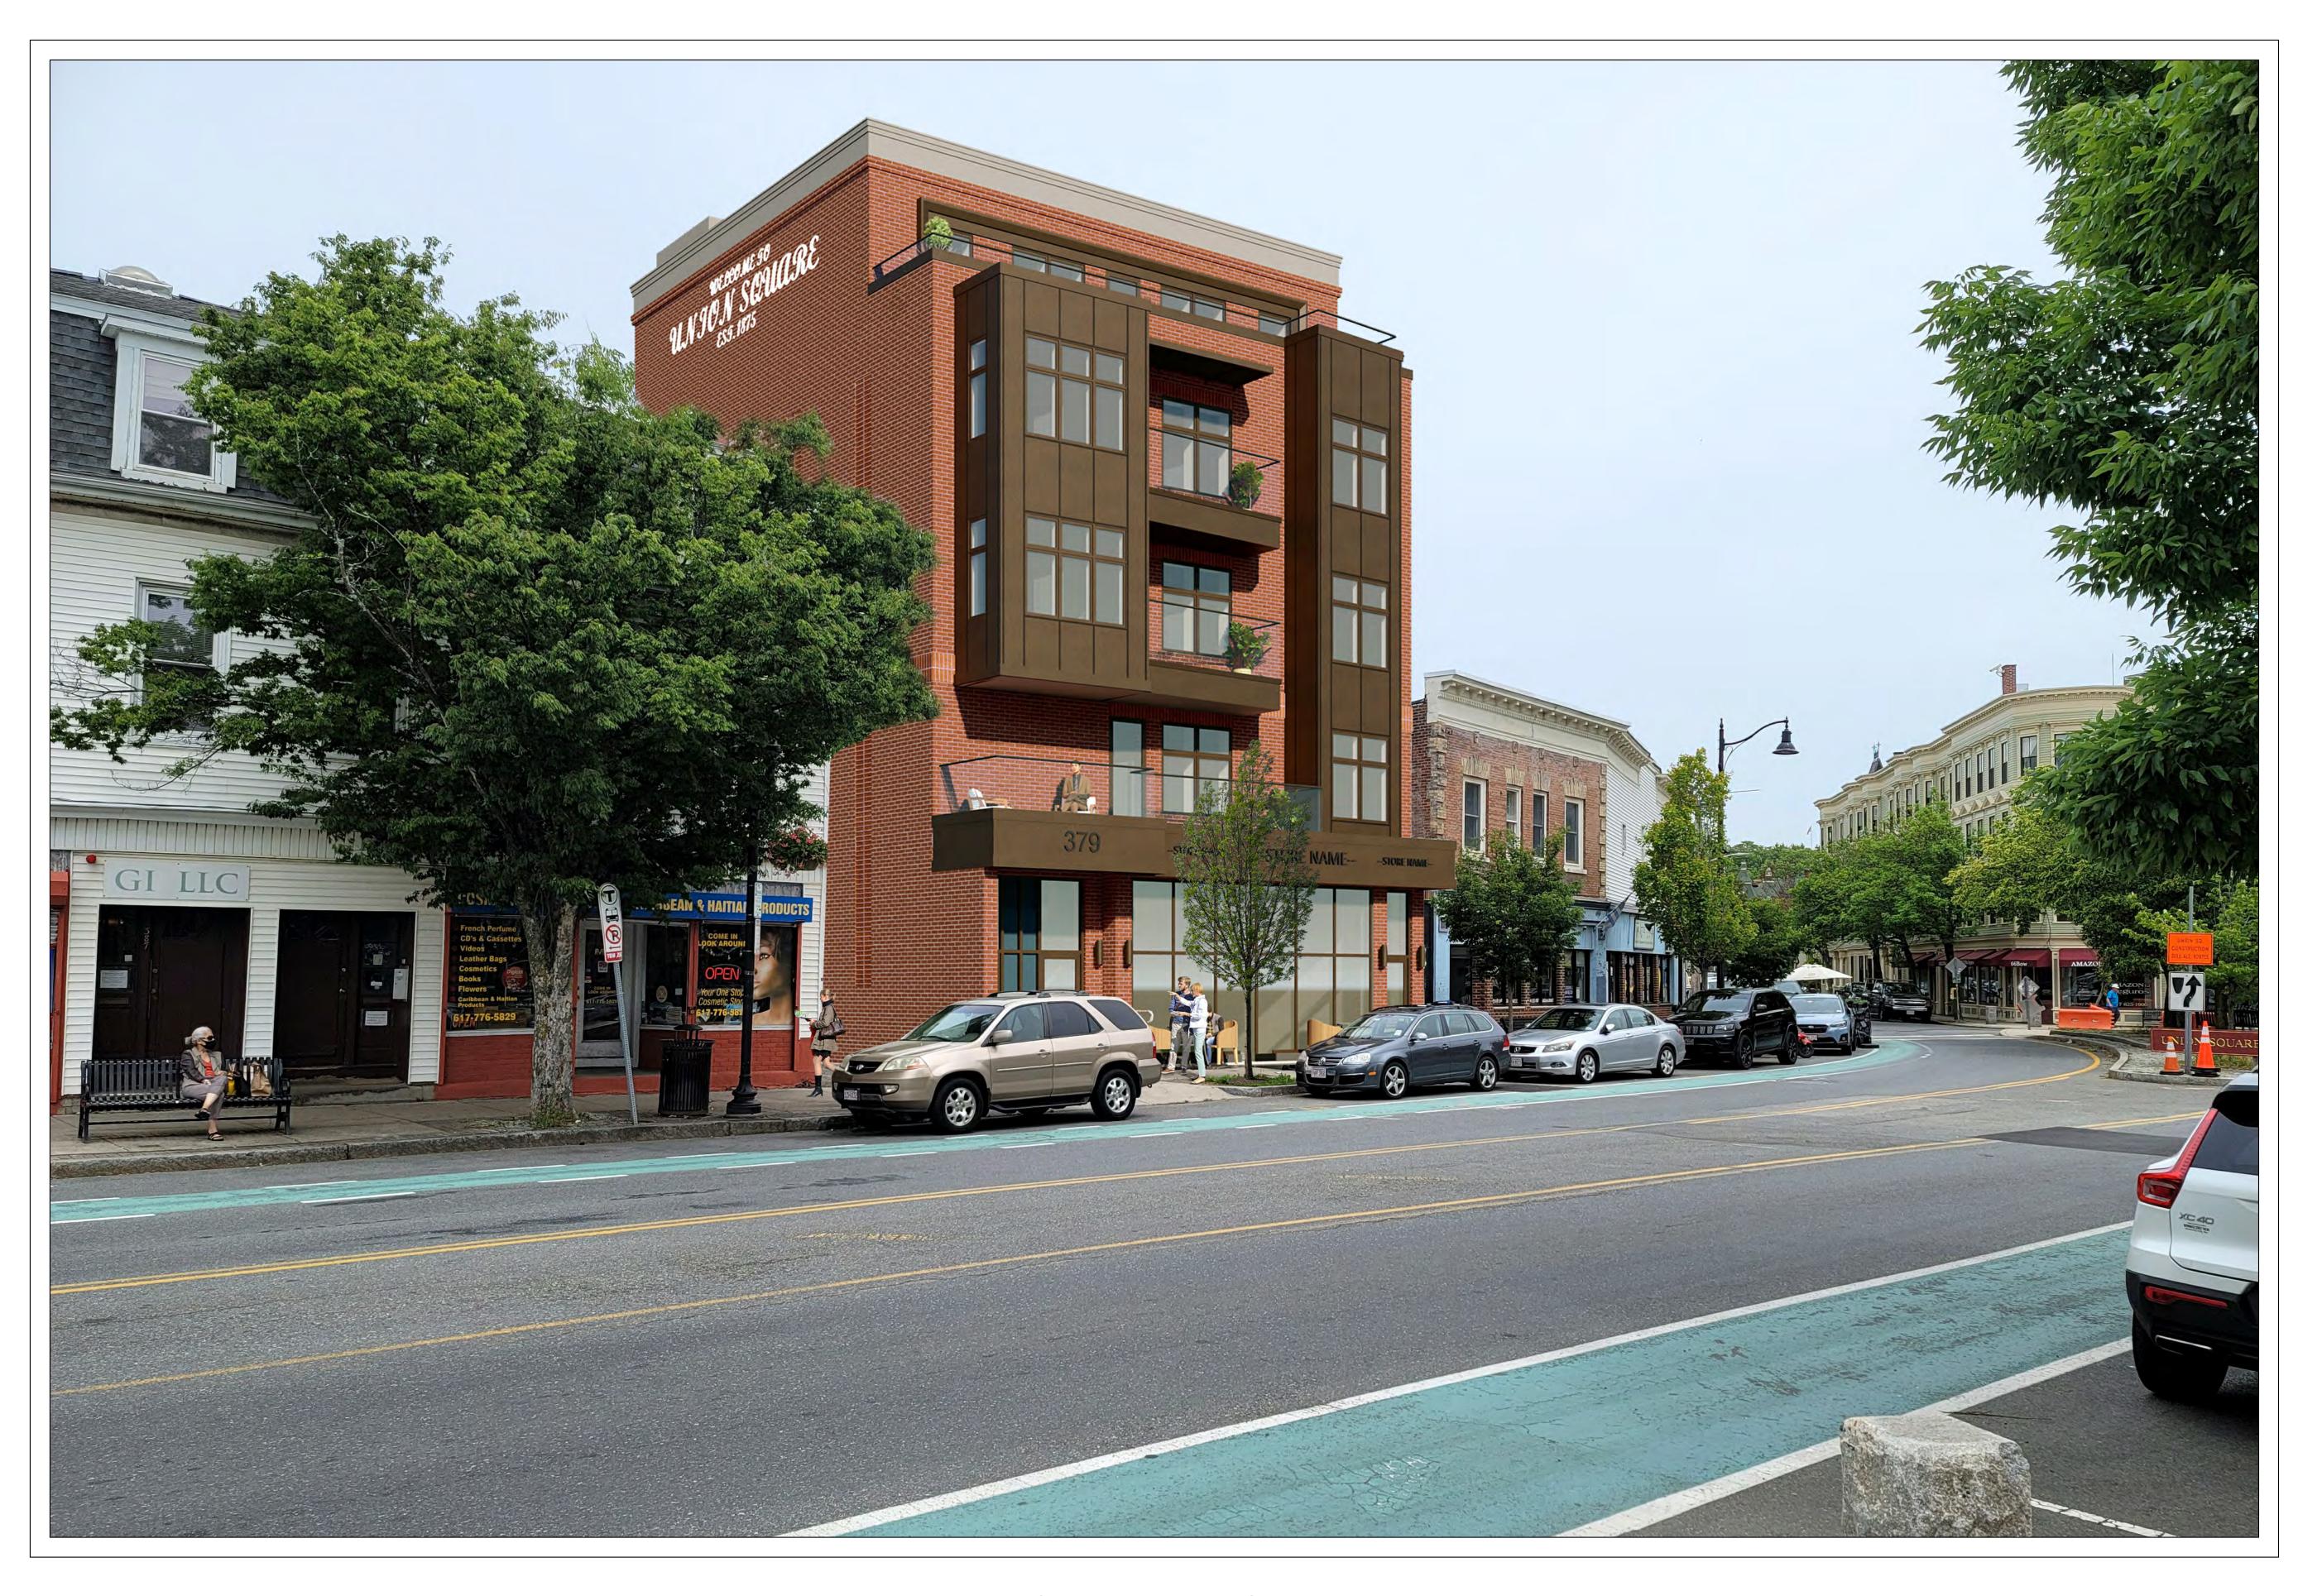

STREET PERSPECTIVE RENDERING VIEW

PROJECT NAME

THUNDER ROAD

PROJECT ADDRESS

379 Somerville Ave Somerville, MA

CLIENT

379 SOMERVILLE AVE, LLC

ARCHITECT



17 IVALOO STREET SUITE 400 SOMERVILLE, MA 02143 TELEPHONE: 617-591-8682 FAX: 617-591-2086

CONSULTANTS:

COPYRIGHT KDI © 2019
THESE DRAWINGS ARE NOW AND DO
REMAIN THE SOLE PROPERTY OF KHALSA
DESIGN INC. USE OF THESE PLANS OR ANY

REGISTRATION

Project nu	ımber	190
Date		5/18/20
Drawn by		
Checked	by	J:
Scale		
REVISI	ONS	
No.	Description	Date

RENDERING

AV-2





STREET PERSPECTIVE RENDERING VIEW COLOR OPTION 2

PROJECT NAME

THUNDER ROAD

PROJECT ADDRESS

379 Somerville Ave Somerville, MA

CLIENT

379 SOMERVILLE AVE, LLC

ARCHITECT



17 IVALOO STREET SUITE 400 SOMERVILLE, MA 02143 TELEPHONE: 617-591-8682 FAX: 617-591-2086

CONSULTANTS:

COPYRIGHT KDI © 2017
THESE DRAWINGS ARE NOW AND DO
REMAIN THE SOLE PROPERTY OF KHALSA
DESIGN INC. USE OF THESE PLANS OR ANY



Project no	umber	19041
_Date		6/02/2021
Drawn by		WC
Checked	by	JSK
Scale		
REVISI	ONS	
No.	Description	Date

Rendering

AV-3 THUNDER ROAD